DEVELOPMENT PARAMETERS

: 18,505m² (ABOUT) : 14,076m² (ABOUT) APPLICATION SITE AREA COVERED AREA UNCOVERED AREA : 4,429m2 (ABOUT)

PLOT RATIO SITE COVERAGE : 0.96 (ABOUT) : 76% (ABOUT)

NO. OF STRUCTURE DOMESTIC GFA : N/A


NON-DOMESTIC GFA : 17,759m2 (ABOUT) BUILDING HEIGHT : 3m - 12m (ABOUT)

NO. OF STOREY :1-2

STRUCTURE	USE	COVERED AREA	GFA	BUILDING HEIGHT
B1	LOGISTIC CENTRE	12,917m² (ABOUT)	16,287m² (ABOUT)	12m (ABOUT)(2-STOREY)
B2	SITE OFFICE	313m² (ABOUT)	626m² (ABOUT)	6m (ABOUT)(2-STOREY)
B3	STAFF CANTEEN	167m² (ABOUT)	167m² (ABOUT)	3.5m (ABOUT)(1-STOREY)
B4	SITE OFFICE	15m² (ABOUT)	15m² (ABOUT)	3m (ABOUT)(1-STOREY)
B5	SITE OFFICE	15m² (ABOUT)	15m² (ABOUT)	3m (ABOUT)(1-STOREY)
B6	SITE OFFICE	15m² (ABOUT)	15m² (ABOUT)	3m (ABOUT)(1-STOREY)
B7	FS WATER TANK	56m² (ABOUT)	56m² (ABOUT)	5m (ABOUT)(1-STOREY)
B8	RAIN SHELTER	56m² (ABOUT)	578m² (ABOUT)	6.2m (ABOUT)(1-STOREY)

14,076m² (ABOUT) 17,759m² (ABOUT)

**EXCLUDING COMMON AREA OF B2, B5 AND B6

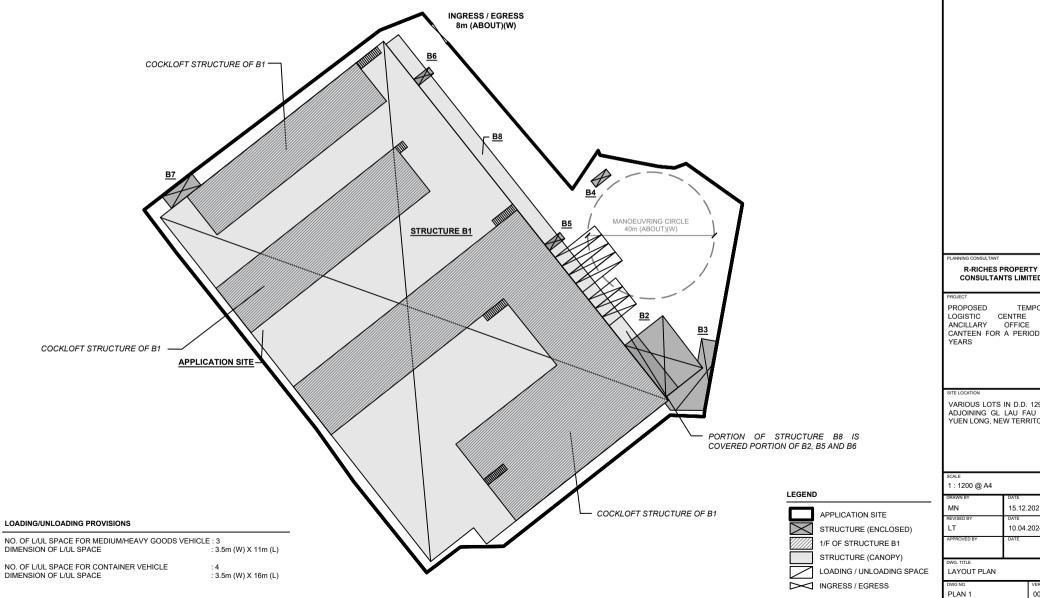



CONSULTANTS LIMITED

TEMPORARY LOGISTIC CENTRE WITH OFFICE AND CANTEEN FOR A PERIOD OF 3

VARIOUS LOTS IN D.D. 129, AND ADJOINING GL LAU FAU SHAN, YUEN LONG, NEW TERRITORIES

I : 1200 @ A4	
RAWN BY	DATE
MN	15.12.2021
EVISED BY	DATE
_T	10.04.2024

003

F.S.NOTES:

1. GENERAL

- 1.1 FIRE SERVICE INSTALLATIONS SHALL BE PROVIDED IN ACCORDANCE WITH THE CODES OF PRACTICE FOR MINIMUM FIRE SERVICE INSTALLATIONS AND EQUIPMENT AND INSPECTION, TESTING AND MAINTENANCE OF INSTALLATIONS AND EQUIPMENT 2022 (COP 2022), FSD CIRCULAR LETTERS AND THE HONG KONG WATERWORKS STANDARD REQUIREMENTS.
- 1.2 ALL TUBES AND FITTINGS SHALL BE G.M.S. TO BS1387 MEDIUM GRADE WHERE PIPEWORK UP TO Ø150mm.
- 1.3 ALL TUBES AND FITTINGS SHALL BE DUCTILE IRON TO BS EN545 K12 WHERE PIPEWORK ABOVE Ø150mm.
- 1.4 ALL DRAIN PIPES SHALL BE DISCHARGED TO A CONSPICUOUS POSITION WITHOUT THE POSSIBILITY OF BEING SUBMERGED.
- 1.5 ALL PUDDLE FLANGES SHALL BE MADE OF DUCTILE IRON
- 1.6 THE AGGREGATE AREA OF OPENABLE WINDOWS NOT LESS THAN 6.25% OF THE FLOOR AREA OF THE STRUCTURE
- 1.7 VENTILATION/AIR CONDITIONING SYSTEM NOT TO BE PROVIDED.

2. HOSE REEL SYSTEM

- 2.1 NEW FIRE HOSE REEL SHALL BE PROVIDED AS INDICATED ON PLAN TO ENSURE THAT EVERY PART OF THE BUILDING CAN BE REACHED BY A LENGTH OF NOT MORE THAN 30m HOSE REEL TUBING.
- 2.2 THE WATER SUPPLY FOR HOSE REEL SYSTEM WILL BE FED FROM A NEW 2m3 F.S. FIBREGLASS WATER TANK VIA TWO HOSE REEL PUMPS (DUTY/ STANDBY) LOCATED INSIDE FS PUMP ROOM AT EXTERNAL AREA.
- 2.3 HOSE REEL PUMPS SHALL BE STARTED BY ACTUATION OF ANY BREAKGLASS UNIT FITTED ASIDE EACH HOSE REEL SETS
- 2.4 ALL FIRE HOSE REEL OUTLETS SHOULD BE HOUSED IN GLASS FRONTED CABINET SECURED UNDER LOCK & KEY.
- 2.5 ALL FIRE HOSE REEL SHOULD BE PROVIDED WITH FSD APPROVED TYPE INSTRUCTION PLATE & WSD WARNING PLATE
- 2.6 SECONDARY ELECTRICITY SUPPLY DIRECTLY TEE OFF BEFORE CLP'S INCOMING MAIN SWITCH SHALL BE PROVIDED FOR THE FH/HR PUMPS.

3. AUTOMATIC SPRINKLER SYSTEM

- 3.1 NEW AUTOMATIC SPRINKLER SYSTEM SHALL BE PROVIDED AND INSTALLED IN ACCORDANCE WITH LPC RULES FOR AUTOMATIC SPRINKLER INSTALLATIONS INCORPORATING BS EN 12845: 2015 (INCLUDING TECHNICAL BULLETINS, NOTES, COMMENTAR AND RECOMMENDATIONS) AND FSD CIRCULAR LETTER NO. 5/2020. THE CLASSIFICATION OF THE OCCUPANCIES WILL BE ORDINARY HAZARD GROUP III.
- 3.2 ONE NEW 135m3 SPRINKLER WATER TANK WILL BE PROVIDED AS INDICATED ON PLAN. THE TOWN MAIN WATER SUPPLY WILL BE FED FROM SINGLE END.
- 3.3 TWO NEW SPRINKLER PUMPS (DUTY/STANDBY) AND ONE JOCKEY PUMP SHALL BE PROVIDED IN FS PUMP ROOM LOCATED AT EXTERNAL AREA.
- 3.4 NEW SPRINKLER CONTROL VALVE SET AND SPRINKLER INLET SHALL BE PROVIDED AS INDICATED ON PLAN.
- 3.5 A TEST VALVE SHALL BE PROVIDED FOR EACH ZONE OF SPRINKLER PIPE. THIS VALVE SHALL BE AT A CONSPICUOUS POSITION THAT WATER CAN BE DRAINED AWAY EASILY.
- 3.6 ALL SUBSIDIARY STOP VALVES TO BE ELECTRIC MONITORING TYPE.
- 3.7 ALL ELECTRIC TYPE VALVES SHOULD GIVE VISUAL SIGNALS TO FIRE SERVICE MAIN SUPERVISORY CONTROL PANEL TO INDICATE THE STATUS (OPEN/CLOSE) OF THE VALVES.
- 3.8 SECONDARY ELECTRICITY SUPPLY DIRECTLY TEE OFF BEFORE CLP'S INCOMING MAIN SWITCH SHALL BE PROVIDED FOR THE SPRINKLER PUMPS.
- 3.9 THE SPRINKLER SYSTEM DESIGN IS BASED ON THE FOLLOWINGS: HAZARD CLASS: ORDINARY HAZARD GROUP III TYPE OF STORAGE: POST-PALLET (ST2) STORAGE CATEGORY: CATEGORY I MAXIMUM STORAGE HIEGHT: 3.5m SPRINKLER PROTECTION: CEILING PROTECTION ONLY
 - THE MAXIMUM STORAGE AREAS SHALL BE 50m FOR SINGLE BLOCK THE MINIMUM CLEARANCE AROUND EACH SINGLE STORAGE CLOCK: 2.4m

4. FIRE ALARM SYSTEM

- 4.1 NEW FIRE ALARM SYSTEM SHALL BE PROVIDED IN ACCORDANCE WITH BS 5839-1:2017 AND FSD CIRCULAR LETTERS NO. 6/2021.
- 4.2 NEW BREAKGLASS UNITS AND FIRE ALARM BELLS SHALL BE PROVIDED AT ALL³ NEW FIRE HOSE REEL POINTS. THE FIRE ALARM INTALLATION WILL BE INTEGRATED WITH THE HOSE REEL SYSTEM.

5. EMERGENCY LIGHTING

5.1 EMERGENCY LIGHTING SHALL BE PROVIDED IN ACCORDANCE WITH 'BS 5266-1:2016 AND BS EN 1838:2013", AND THE FSD CIRCULAR LETTER NO. 4/2021, COVERING ALL AREA. EMERGENCY LIGHTINGS SHALL BE BACKED UP BY BUILT-IN BATTERY AND CAPABLE OF MAINTAINING FUNCTION OF NOT LESS THAN 2 HOURS IN CASE OF POWER FAILURE

6. EXIT SIGN

6.1 ALL EXIT SIGNS/DIRECTIONAL EXIT SIGNS SHALL BE PROVIDED IN ACCORDANCE WITH BS 5266-1:2016 AND FSD CIRCULAR LETTER NO. 5/2008, FOR THE BUILDING. EXIT SIGNS/DIRECTIONAL EXIT SIGNS SHALL BE BACKED UP BY BUILT-IN BATTERY AND CAPABLE OF MAINTAINING FUNCTION OF NOT LESS THAN 2 HOURS IN CASE OF POWER FAILURE.

7. PORTABLE APPLIANCES

7.1 PORTABLE HAND OPERATED APPLIANCES SHALL BE PROVIDED AS INDICATED ON PLAN.

LEGEND

HR HOSE REEL

BREAK GLASS UNIT

FIRE ALARM BELL

EXIT EXIT SIGN

NON-RETURN VALVE

FIRE EXTINGUISHER

SAND BUCKET SUBSIDIARY VALVE / FLOW SWITCH SPRINKLER CONTROL VALVE SET

GATE VALVE

GATE TYPE (With MONITORING)

REV DESCRIPTION DATE

Y-TYPE STRAINER SPRINKLER INLET

SPRINKLER HEAD (ON PLAN)

5KG DRY POWDER FIRE EXTINGUISHER


PRESSURE GAUGE

PROPOSED TEMPORARY LOGISTIC CENTRE ANCILLARY OFFICE CANTEEN FOR A PERIOD OF 3 YEARS VARIOUS LOTS IN D.D. 129, AND ADJOINING GL LAU FAU SHAN, YUEN LONG, NEW TERRITORIES

DRAWING TITLE: F.S. Notes, Legend, Fire Service Installation **Layout Plan**

ARCHITECT : CONSULTANT FIRE SERVICE CONTRACTOR **Century Fire Service** Engineering Co., Ltd. CHECKED BY

DRAWING NO : REV. **FS-01** C.K. NG 27 Mar 2024 SCALE: 1:1000 (A1) B.O.O. Ref. BD APPROVED BY F.S.D. Ref. FP

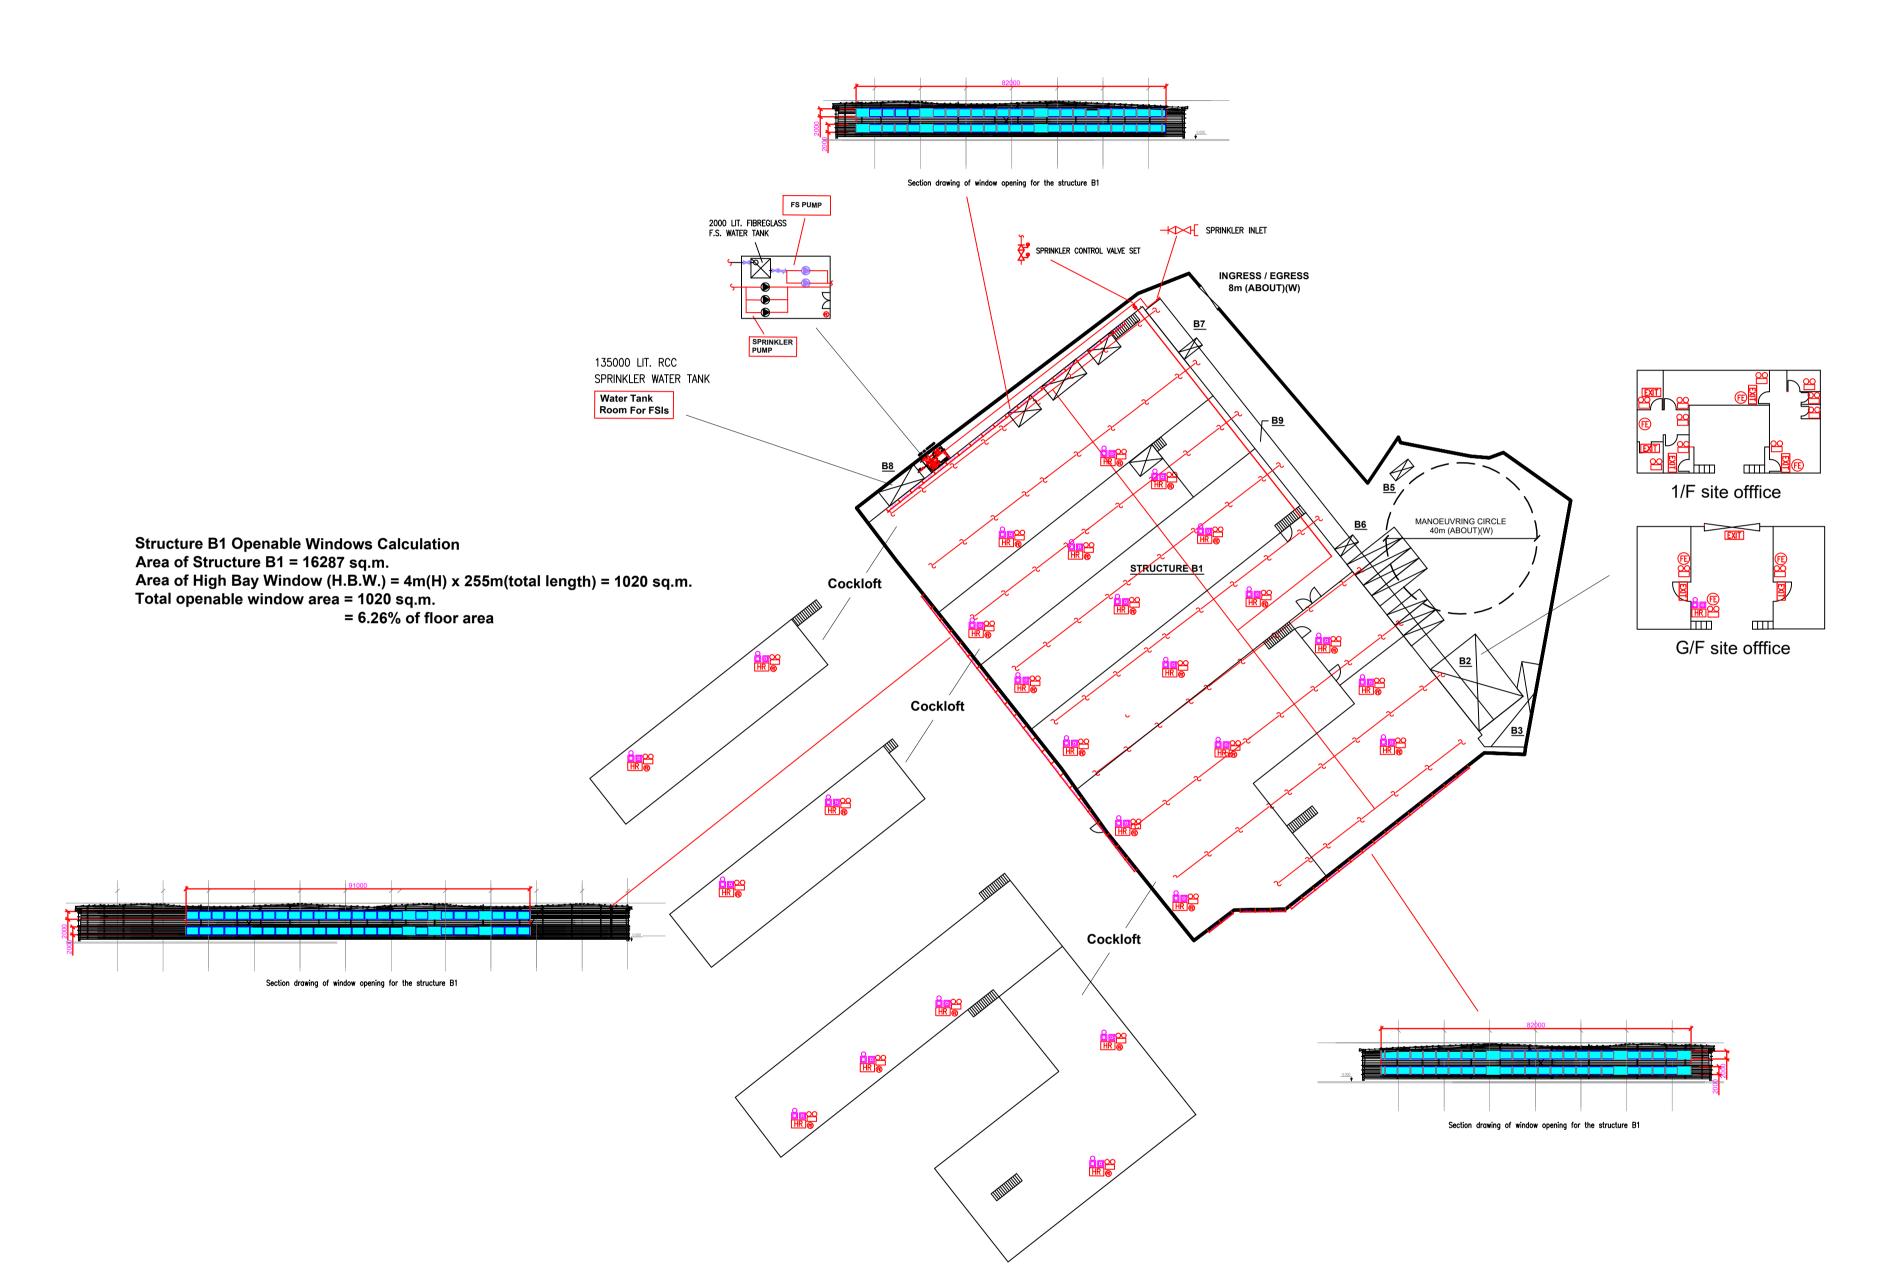

STRUCTURE USE

COVERED AREA

167m2 (ABOUT)

15m2 (ABOUT)

15m2 (ABOUT)

56m2 (ABOUT)

578m2 (ABOUT)**

16.287m2 (ABOUT)

167m2 (ABOUT

15m2 (ABOUT)

15m2 (ABOUT)

56m2 (ABOUT)

14,076m2 (ABOUT) 17,759m2 (ABOUT)

578m2 (ABOUT)**

LOGISTIC CENTRE 12.917m2 (ABOUT)

STAFF CANTEEN

SITE OFFICE

SITE OFFICE

RAIN SHELTER

BUILDING HEIGHT

3.5m (ABOUT)(1-STORE)

3m (ABOUT)(1-STORE

3m (ABOUT)(1-STOREY)

6.2m (ABOUT)(1-STOREY

