Date: 07 June, 2024

TPB Ref: TPB/A/TM-LTYY/473

Town Planning Board 15/F, North Point Government Offices 333 Java Road, North Point, Hong Kong

Dear Sir/Madam,

<u>Temporary Shop and Services (Real Estate Agency) for a Period of 3 Years in "Village Type</u> Development" zone at Lot 3674 RP in D.D. 124, Sun Fung Wai, Tuen Mun, New Territories

In reply comments of DSD (Contact Person: Mr. Ryco LEE, Tel: 2300 1629)

The application site granted temporary permission at the date of 2021/07/23 (A/TM-LTYY/413) by Town Planning Board. It is approved use of Temporary Shop and Services (Real estate agency) for period of 3 years which is expiry on 2024/07/23. The applicant has complied with all the approval conditions within the permission period including Drainage proposal and implementation of drainage proposal.

A/TM-LTYY/473 is renewal application which is existing condition as same as previous application. The applicant is now submitted as-built record(P1-P3) for your consideration.

In reply comments of FSD (Contact Person: Mr. YAN Chi-ho, Gary, Tel: 2733 7758)

- 1. The applicant undertaking to confirm there is no change in the layout and proposed uses as compared with the previous application.
- 2. The latest FSI proposal for planning application no LTYY/473 as attached herewith.
- 3. Full set of valid F.S251 covering all the FSIs implemented on the application site as attached herewith and the applicant is requesting FS contractor to conduct annual checking and issue new F.S251 as soon as possible.

Conversation with Planning Department (Mr. Johnny Tam, Tel: 2158 6084)

- 1. The applicant undertaking that No vehicle is allowed to enter application site.
- 2. The applicant clarify that A/TM-LTYY/473 renewal application development parameters as same as A/TM-LTYY/413.


Should you have any enquiries, Please feel free to contact Mr. Chan at


at your convenience.

Yours Faithfully,





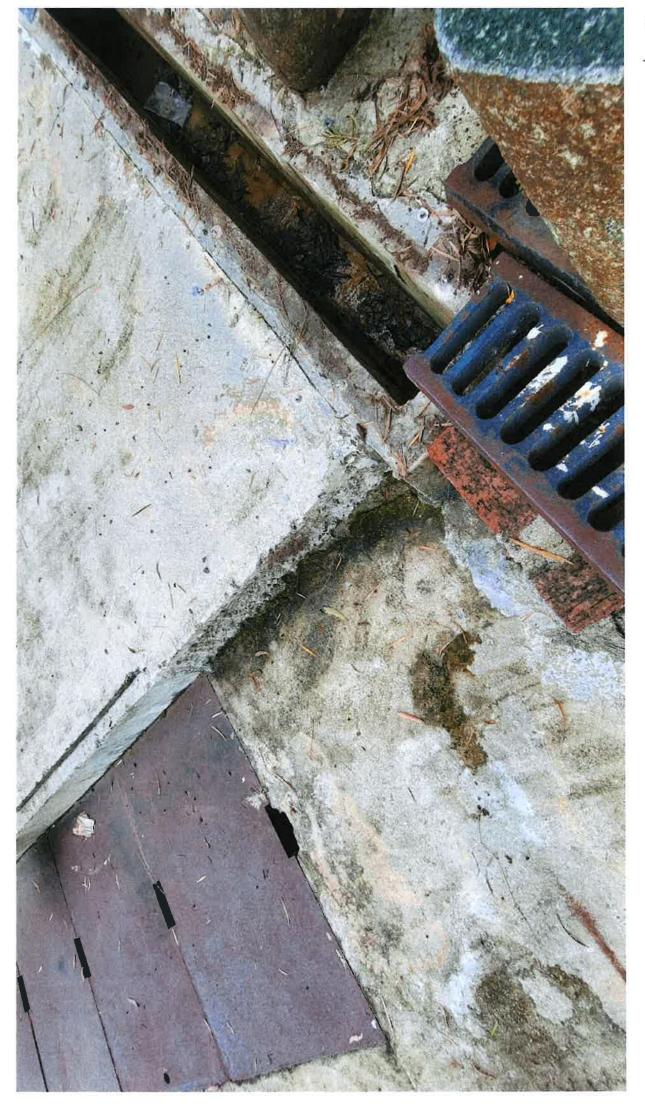

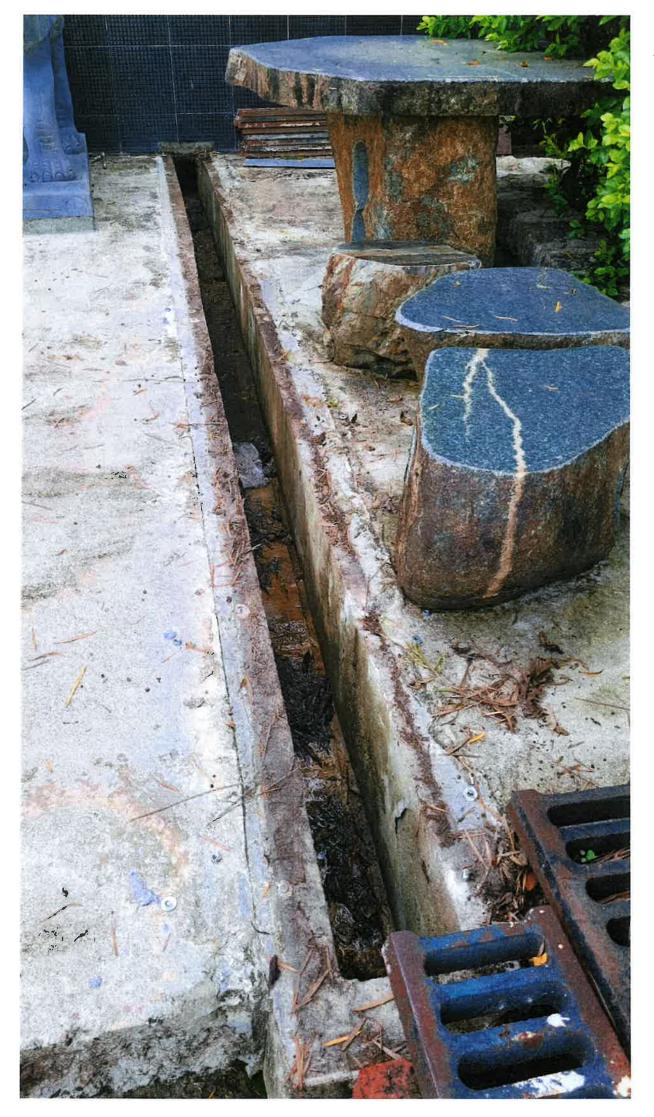

F.S. NOTES:

GENERAL

- FIRE SERVICE INSTALLATIONS AND EQUIPMENT", CLAUSE 4.14, THE PROVISION OF HOSE REEL SYSTEM, FIRE ALARM SYSTEM, EMERGENCY LIGHTING, EXIT SIGN, PORTABLE HAND OPERATED FIRE FIGHTING EQUIPMENT AND SECONDARY SOURCE OF ELECTRICAL SUPPLY SHALL BE PROVIDED FOR THE PROPOSED TEMPORARY SHOP AND SERVICES IN ACCORDANCE WITH "CODES OF PRACTICE FOR MINIMUM
- THE AGGREGATE AREA OF PROPOSED STRUCTURE DOES NOT EXCEED 230M. THUS, AN AUTOMATIC SPRINKLER SYSTEM SHOULD NOT BE INSTALLED.
- EQUIPMENT APRIL HOSE REELS REFER TO CLAUSE 5.14(b) IN THE CODE RACTICE FOR MINIMUM FIRE SERVICE INSTALLATION AND 2012. 읶

H.R. SYSTEM

- 1. ON-OFF TYPE HOSE REEL NOZZLES HOUSED IN GLASS-FRONTED CABINETS WITH PADLOCKS SHALL BE INSTALLED AT LOCATION NOT HIGHER THAN 1350 AFFL.
- HOSE REEL INSTRUCTION PLANS SHALL BE PROVIDED L HOSE REELS. R

F/B

F/A

ABBREVIATIONS

- THE LENGTH OR RUBBER HOSES SHALL NOT 30m. BE MORE THAN
- DUTY AND STANDBY FIXED FIRE PUMPS OVIDED FOR THE HOSE REEL SYSTEM. SHOULD 먪
- MANUAL FIRE ALARM CONTROL PANEL SHOULD E PROVIDED AS INDICATED ON G/F FOR FIRE ALE THE HOSE REEL SYSTEM. ALARM SIGNALS

M/L

7

1/B T/A

7

AFF

- 6. THE HOSE REEL BRANCH NOZZLE SHALL HAVE A 4.5mm ORIFICE AND BE FITTED WITH A SIMPLE TWO WAY VALVE TO OPEN OR SHUT OFF JET. THE VALVE MUST NOT BE SPRING
- ALL FIRE SERVICE INSTALLATIONS SHOULD FULLY COMPLY WITH THE CURRENT REQUIREMENTS OF THE FIRE SERVICES DEPARTMENT AND THE WATER SUPPLIES DEPARTMENT.

F.S.

돐

Z I

Y.P

- 8. HOSE REELS REFER TO CLAUSE 5.14(b) IN THE CODE PRACTICE FOR MINIMUM FIRE SERVICE INSTALLATION AND EQUIPMENT APRIL 2012. 유
- 9. ELECTRICAL CABLES FOR FIRE ALARM BELLS AND FIRE SERVICES PUMPS SHALL BE FIRE RESISTING TYPE COMPLYING WITH BS6387 CAT CWZ.

0.F

MFA

MANUAL

FIRE ALARM

P

ASSEMBLY

SWITCH

R

EMERGENCY LIGHT

(WALL MOUNT)

__ FLASHING LIGHT

5Kg CO2 PORTABLE FIRE EXTINGUISHER

EXIT

EXIT SIGN

묨 COLOUR SIZE

GREEN PURPLE COLOUR FOR

CODE

PIPE

SIZE

10. A NEW FIBERGLASS F.S. W STORAGE CAPACITY NOT LESS PROVIDED ON G/F FOR HOSE WATER SE REEL R TANK OF EFFECTIVE N 2000 LITERS SHALL L L SYSTEM. 먪


FIRE ALARM SYSTEM

- ACTUATION OF ANY BREAKGLASS UNIT IN THE BUILDING START THE FIXED FIRE PUMP AND SOUND ALL THE ALARM BELLS IN THE WHOLE BUILDING. ×
- 2. THE CAPACITY OF BATTERY IS SUFFICIENT TO MAINTAIN THE SYSTEM IN NORMAL CONDITION FOR 24 HOURS (A.F.A. SYSTEM) AND IT SHALL BE ABLE TO OPERATE THE SYSTEM AT ALARM CONDITION FOR 30 MINUTES.

OTHERS

- 1. ALL EXITS AND EXIT ROUTES SHALL COMPLY WITH CODE OF PRACTICE & FSD C.L. 5/08 AND TO BE CLEARLY INDICATED BY ILLUMINATED "EXIT" "HIT" SIGN AND DIRECTIONAL SIGNS IN CHINESE AND ENGLISH CHARACTERS OF NOT LESS THAN 125MM HIGH W/. 15MM WIDE STROKES.
- EMERGENCY LIGHTING SHALL COMPLY WITH BS EN 1838/1999 AND TO BE PROVIDED THROUGHOUT THE ENTIRE BUILDING AND SHALL COMPLY WITH BS 5266; PART 1 AND I EN 1838 EXCEPT THAT OF EXIT SIGNS. BS
- THE PROPOSED SECONDARY SOURCE OF THE ELECTRICAL SUPPLY IS TEED OFF BEFORE THE INCOMING MAIN SWITCH FOR THE ESSENTIAL LOADING OF THE FIRE SERVICES INSTALLATIONS.

OVERFLOW PIPE	VENT PIPE	ACCESS MANHOLE	FIRE HOSE REEL	FIRE SERVICES	ABOVE FINISHED FLOOR LEVEL	HIGH LEVEL	MIDDLE LEVEL	LOW LEVEL	TO BELOW	TO ABOVE	FROM BELOW	FROM ABOVE	ATIONS
Ō	-⊠	ð	. Σ	X	\bigcirc	FSPA	FSPP		MFAP	Ħ		。 国	LEGENDS
CHECK METER POSITION	AUTOMATIC AIR VENT	BALL FLOAT VALVE	CHECK VALVE	GATE VALVE	FIXED FIRE PUMP	FIXED FIRE PUMP SETS ARRANGEMENT	CONTROL PANEL	EIXED EIRE DIMP	MFA CONTROL PANEL	FIRE ALARM BELL	MFA CALL POINT UNIT (BREAKGLASS TYPE)	FIRE HOSE REEL	(U)
cidifactor (no now)	Standby fixed fire pumps changever (No flow)			PRESSURE SWITCH AS						BLOCK PLAN (NT			S. C.

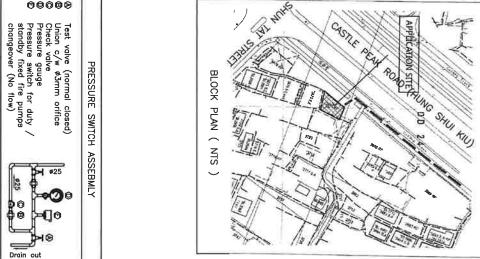

LAYOUT PLAN OF PROPOSED TEMPORARY SHOP AND SERVICE (REAL ESTATE AGENCY) AT LOT 3674 RP IN D.D124, SUN FUNG WAI, TUEN MUN, N.T.


Drawing Title:

F.S. NOTES, ABBREVIATIONS, LEGENDS, BLOCK PLAN, COLOUR CODE FOR PIPE SIZE AND PRESSURE SWITCH ASSEBMLY

FSI Contractor

基業消防工程有限公司 KEI YIP FIRE ENGINEERING LTD

Cad Ref: PTS/FS/	DWG-01	Dwg. Date: 17-NOV-2015	Dwg. No. FS-01	Rev	
Scale: NTS		Drawn: P.L. YAU	Checked: CAD		
DATE		DESCRIPTION			
4/2017	AS PÉI	AS PER PLANNING DEPARTMENT COMMENT 30/3/2017			
11/2018		AS-FIITED			
2/2022	AS PER PLANNING DEPARTMENT COMMENT 22/2/2022				

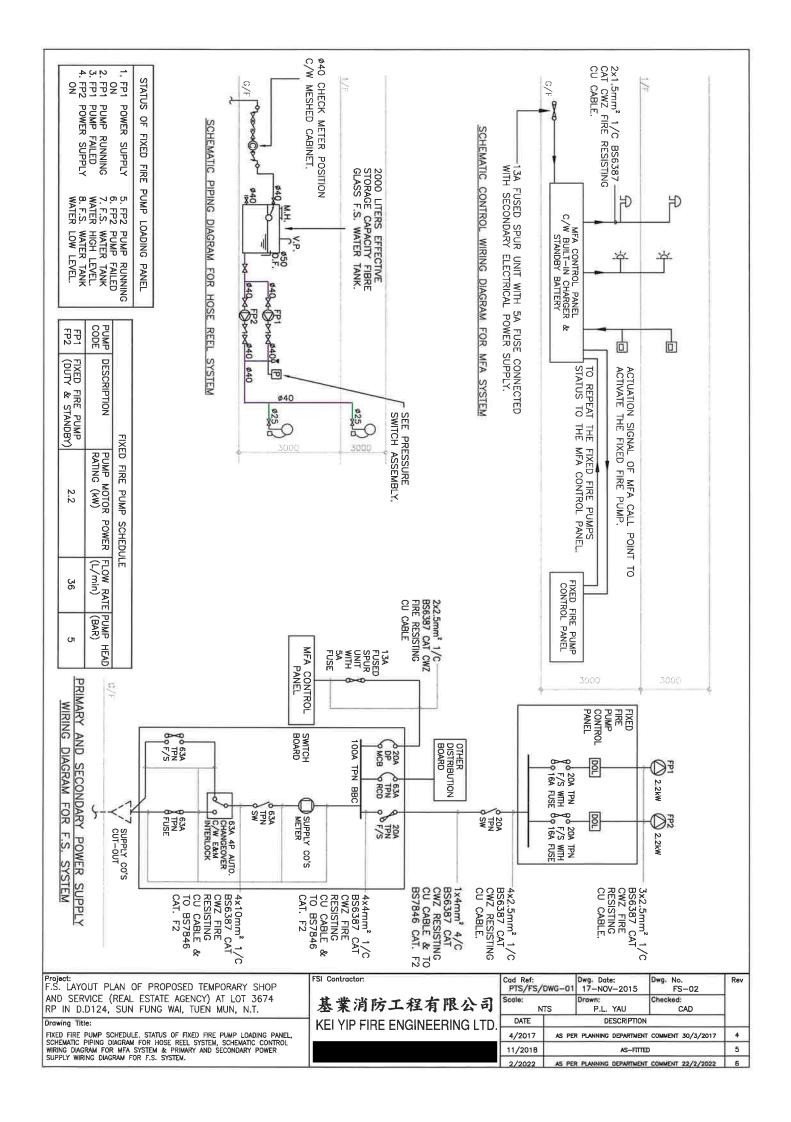



Drawing Title: F.S. FLOOR LAYOUT PLAN OF GROUND FLOOR AND FIRST FLOOR, FIXED FIRE PUMP SETS ARRANGEMENT & CHECK METER POSITION

Project F.S. LAYOUT PLAN OF PROPOSED TEMPORARY SHOP RP IN D.D124, SUN FUNG WAI, TUEN MUN, N.T.

MEI YIP FIRE ENGINEERING LTD. 基業消除工程有限公司

9	T COMMENT 22/2/2022	R34 SA	5/5055		
ç	Œ		4/2017		
*	T COMMENT 30/3/2017	434 2A			
	1		DATE		
	CVD CVD	Drawn: P.L. YAU	ΣΑ © 00] : 10	
кел	FS-03	17-NOV-2015	PTS/FS/DWG-01		

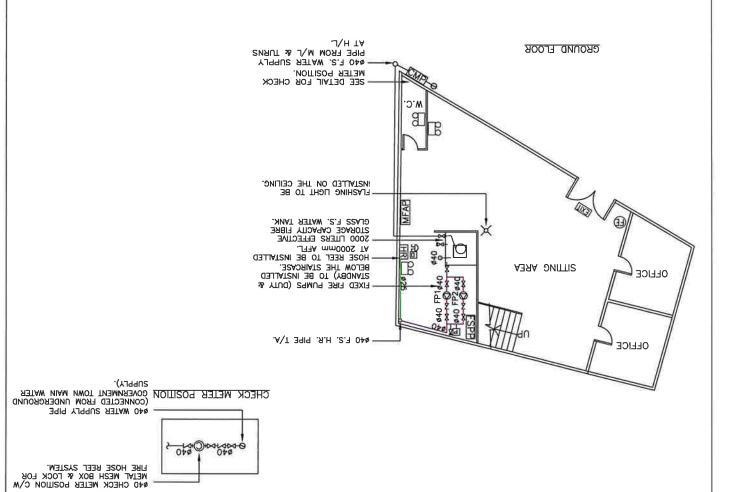

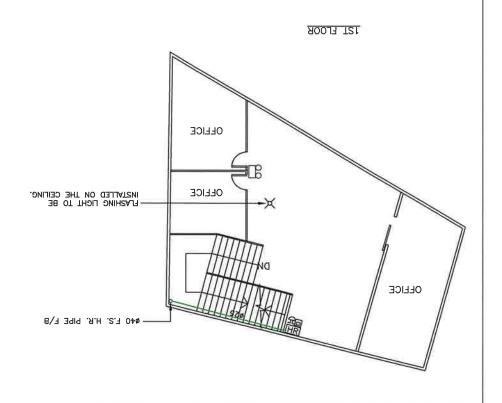

FIRE SERVICE (INSTALLATIONS AND EQUIPMENT) REGULATIONS

消防(裝置及設備)規例

(Regulation 9(1))

A 8950190

FSD Ref.: __ 消防處檔號

(第九條(1)款) CERTIFICATE OF FIRE SERVICE INSTALLATION AND EQUIPMENT 消防裝置及設備證書

			用的农豆及政用盈 盲				
Name of 顧客姓名	From Channa	Security and P	roperty Management Limited				
Name of 樓字名科	Building: 解						
	o./Town Lot: 数/市地段 71	6	Street/Road/Estate Name: 街道/屋苑名稱	Sun Fung Wai	Sun Fung Wai		
Block: 座		District 分區		Area: HK 版 香港	NT 九龍 ✓ 新界		
	Building 樓宇類型:□Indu		1 1 1 1 1 1 1 1 1 1 1 1 1 1 1 1 1 1 1	mposite综合 Licensed prem	ises持牌處所 Institutional		
	t 1 Annual Inspection C 一部 只適用於年檢	·東頂 equip	cordance with Regulation 8(b) of Fire Service (Install ment which is installed in any premises shall have such in every 12 months. 根據消防(安置及設備)規(1.12個月由一名許冊承重商檢查該等消防裝置或	n fire service installation or equipment inspe 例第八條(b)款,擁有裝置在任何處所	cted by a registered contractor at least		
Code編碼 (1-35)	Type of FSI 装置類型	Location(s) 位置	Comment on Condition 狀況評辨	Completion Date 完成日期(DD/MM/YY)	Next Due Date 下次到期日(DD/MM/YY)		
I		G/F Electronic Technical Workshop	Conforms with FSD requirements.	27/07/2023	26/07/2024		
Part 2 笙	一部 Installation / Mod	ification / Renai	r / Inspection work 装置/改装	/修理/檢查工作			
Code編碼	Type of FSI 裝置類型	Location(s) 位置	Nature of Work Carried out 完成之 Lf		状況評述 Completion Date 完成日期(DD/MM/YY)		
(1-35)		Scotton(e) ER			元成日)别(DD/MIMV 11)		
	NIL		NIL.				
Part 3 第	三部 Defects 損壞事項	į			E THE		
Code編碼 (1-35) Type of FSI 装置類型 Location(s) 位置		Outstanding Defects 未修缺點	Comment on l	Comment on Defects 缺點評述			
	NIL		NIL				
	THE				4 0		
vorking order Equipment and time by the D	rtify that the above installations/equij in accordance with the Codes of Pr Inspection, Testing and Maintenance Director of Fire Services. Defects are lis 登明以上之消防装置及設。	actice for Minimum Fire of Installations and Equipment in Part 3.	e Service Installations and Signate S	ure: 语 me: T. M. KONG GENERAL N	For FSD use only:		
合消防處處	是仍以工之州仍农业及改 定長不時公佈的最低限度. 食查測試及保養守則的規格	之消防装置及設信	精守則與裝置 FSD/RC N	No.: CLAS 碼 CLAS	Inspected		
如證	宣書涉及年檢事 ¹ 處所當眼處以供	頁,應張貼	於大廈 公司名	稱	MAG & CONSULTANTS LTD. 程有限公司 Key-in		
This	s certificate should be displayed at promi for FSD's inspection if any annual		ed.	one : 話 ate : 28/07/2023			

F.S. 251 (Rev. 1/2016)

FIRE SERVICE (INSTALLATIONS AND EQUIPMENT) REGULATIONS 消 防 (裝 置 及 設 備)規 例

(Regulation 9(1)) (第九條(1)款)

A 9151927

FSD Ref.: 消防處檔號

CERTIFICATE OF FIRE SERVICE INSTALLATION AND EQUIPMENT 消防裝置及設備證書

Name of 顧客姓:	51111 (1163)113	Security and Pr	operty Mana	agement Limited				
Name of 樓宇名和	Building: 偁							
	o./Town Lot: 710 數/市地段 710	5	Street/Roa 街道,			Sun Fung Wai		
Block: 座		District 分區	Tue	n Mun	Area: 地區	□HK 香港	K 九龍 MT 新界	
Type of I	Building 樓字類型: Ind				posite综合			土圏
	t 1 Annual Inspection(一部 只適用於年檢	主百 equip	ment which is installed in every 12 months.	in any premises shall have such f	fire service ins 引第八條(b) 統	tallation or equipment inspected 、實有裝置在任何處所內的	of any fire service installation or by a registered contractor at least 5任何消防裝置或設備的人	
Code吳函 (1-35)	Type of FSI 裝置類型	Location(s) 位置	Comment or	Condition 狀況評述	完	Completion Date 成日期(DD/MM/YY)	Next Due Date 下次到期日(DD/MM/YY)	
11	Emergency Lighting (5 NOS)	G/F-1/F	Conform	Conforms with FSD requirements.		27/07/2023	26/07/2024	
12	Exit Sign (1 SET)	G/F	Conforms with FSD requirements.		its.	27/07/2023	26/07/2024	
13	Fire Alarm Systems(MFA)	G/F-1/F	Conform	s with FSD requirement	its.	27/07/2023	26/07/2024	
16	(Including Flashing Light) HR System	G/F-1/F	Conforms with FSD requirements.		ts.	27/07/2023	26/07/2024	
Part 2 第	二部 Installation / Mod	ification / Repair	/ Inspection	work 裝置/改裝/	/修理/ネ			
Code編碼 (1-35)	Type of FSI 裝置類型	Location(s) 位置		Carried out 完成之工作		ment on Condition 狀物	Completion Date 完成日期(DD/MM/YY)	
	NIL		NIL					
							-	
Part 3 第	三部 Defects 損壞事項	i			_			
Code編碼	Type of FSI 裝置類型	Location(s) 位置	Outstandin	Outstanding Defects 未修缺點		Comment on Defects 缺點評述		
(1-35)		Detailer(s) [XII		19 2010000 水形或点		Comment on Del	(高山市) 发生	
	NIL		NIL					
f.							ENGINECO A STATE OF THE STATE	
working order i Equipment and	tify that the above installations/equip in accordance with the Codes of Pra Inspection, Testing and Maintenance frector of Fire Services, Defects are list	ctice for Minimum Fire to the control of Installations and Equips	Service Installations	and Signature	e Z	3226	For FSD use only	
本人藉此證 合消防處處	E明以上之消防装置及設付 E長不時公佈的最低限度= ↑查測試及保養守則的規格	着經試驗,證明性 之消防裝置及設備	守則與裝置	Name 姓名 FSD/RC No 消防處註冊號碼	5. :	Li Cheuk Yuen RC1/484, RC2/453	Inspected	
如證或	書涉及年檢事工 處所當眼處以供 certificate should be displayed at promis for FSD's inspection if any annual n	頁,應張貼 消防處人員 ent location of the building o	於大廈 查核 r premises	Company Name 公司名稱 Telephone 聯絡電記	e: -	Kei Yip Fire Engin	eering Ltd. Key-in	
S. 251 (Rev. 1/2		William of Molk is illivolved		Date 日 助	e: [28/07/2023	Verified	