


場地大綱圖

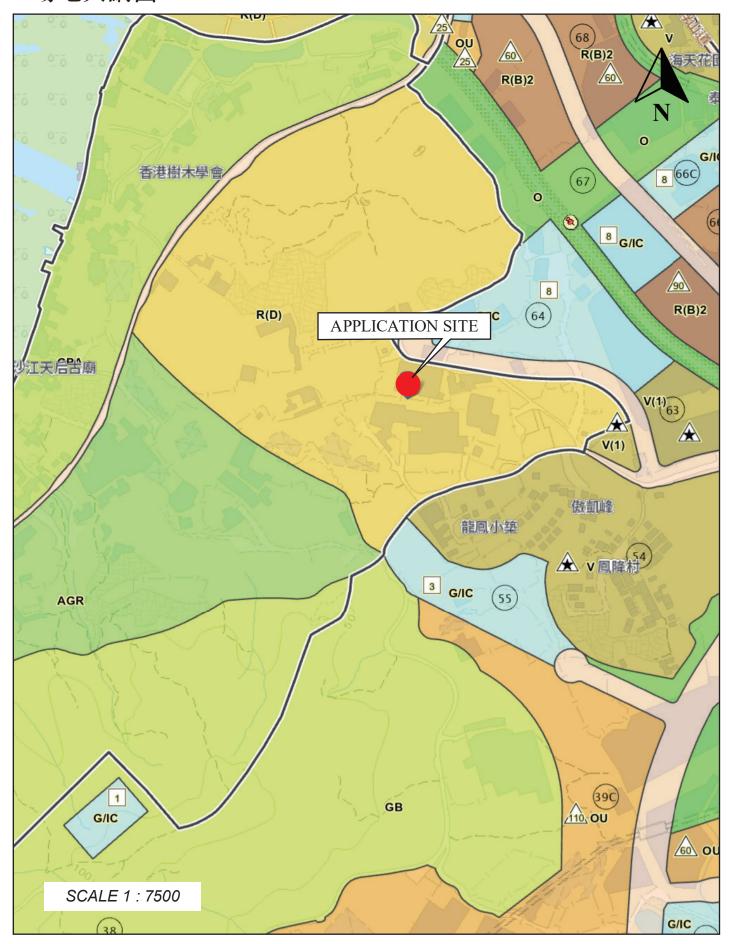

場地位置圖

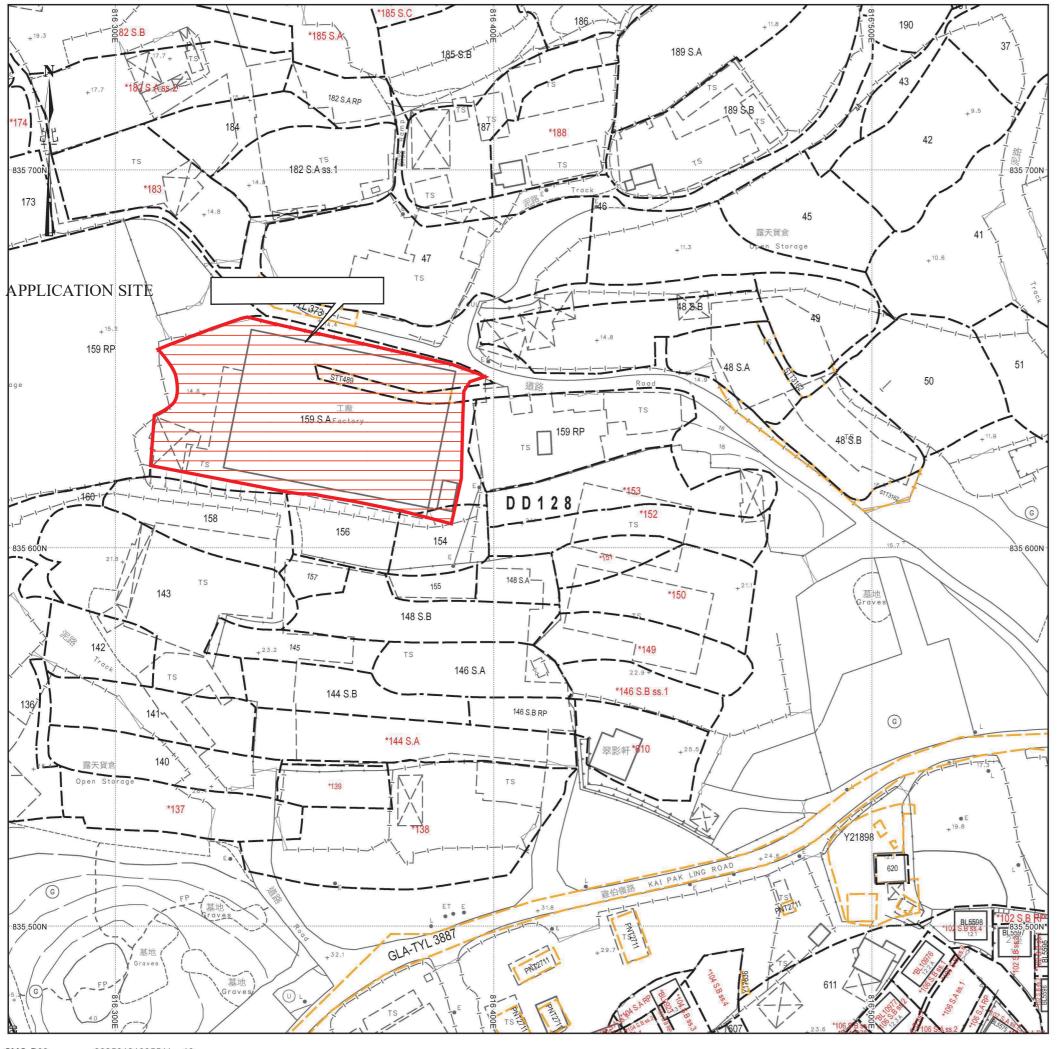

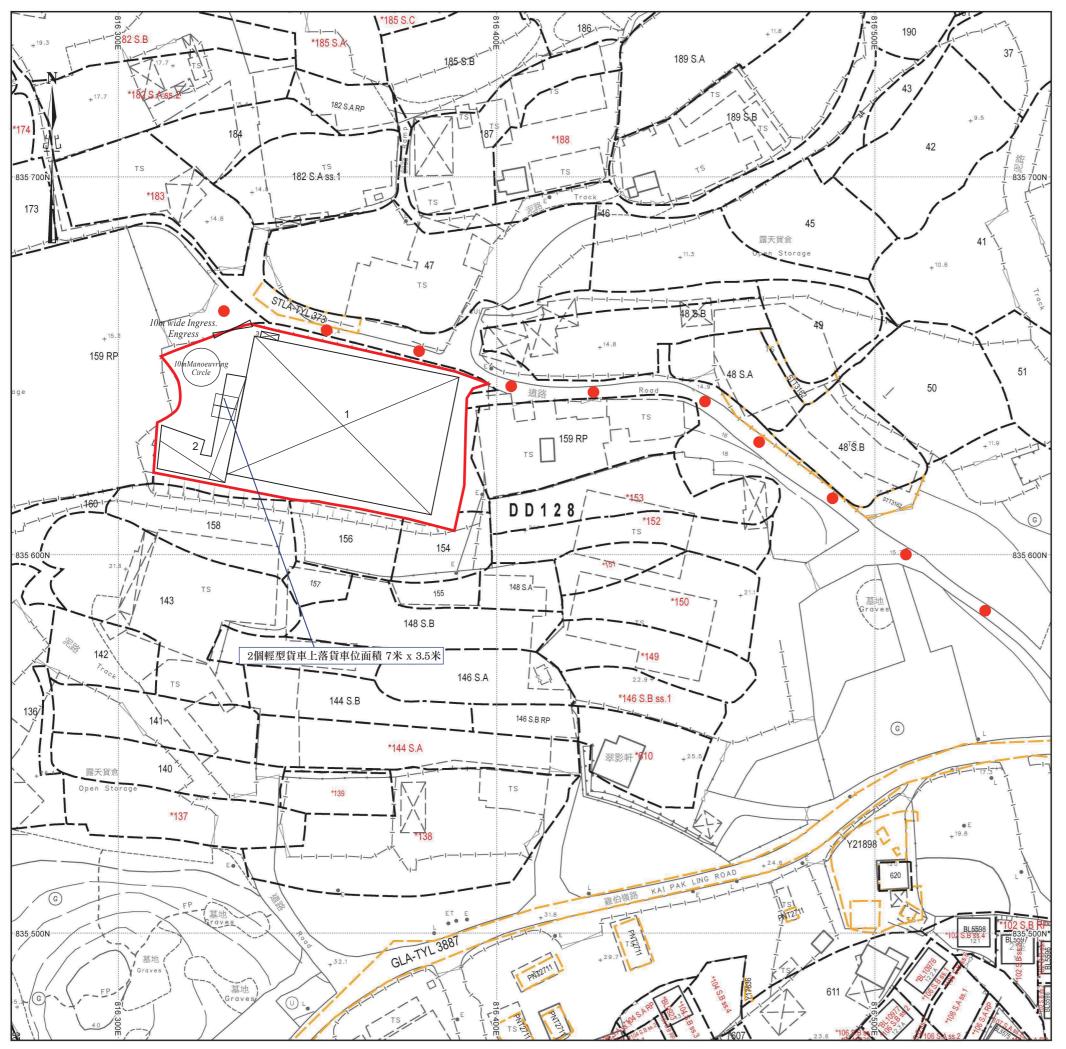

場地設計圖

構築物(1)

用途:可循環再造物料回收中心(電器、電子零件及電池)連附

屬塑膠破碎工場、洗手間、辦公室

建築物料:以金屬搭建

高度:約8米

層數:1層

面積:約2000平方米

總樓面面積:約2285平方米

(當中有一個佔約285平方米的閣樓)

構築物(2)

用途:雨水簷篷

建築物料:以金屬搭建

高度:約6米

層數:1層

面積:約290平方米

總樓面面積:約290平方米

構築物(3)

用途:儲物室

建築物料:以金屬搭建

高度:約3米

層數:1層

面積:約10平方米

總樓面面積:約10平方米

行車路線 SCALE 1: 1000

F.S.NOTES: 1. GENERAL **GF of Structure 1 Openable Windows Calculation** 1.1 FIRE SERVICE INSTALLATIONS SHALL BE PROVIDED IN ACCORDANCE WITH THE CODES OF PRACTICE FOR MINIMUM FIRE SERVICE INSTALLATIONS AND Area of GF Structure 1 = 1310 sq.m. EQUIPMENT AND INSPECTION, TESTING AND MAINTENANCE OF INSTALLATIONS AND EQUIPMENT 2022 (COP 2022), FSD CIRCULAR LETTERS AND THE Area of High Bay Window (H.B.W.) = $2.0m(H) \times 41m(total length) = 82 sq.m.$ HONG KONG WATERWORKS STANDARD REQUIREMENTS. Total openable window area = 82 sq.m. = 6.25% of floor area 1.2 ALL TUBES AND FITTINGS SHALL BE G.M.S. TO BS1387 MEDIUM GRADE WHERE PIPEWORK UP TO Ø150mm. **Cockloft of Structure 1 Openable Windows Calculation** 1.3 ALL TUBES AND FITTINGS SHALL BE DUCTILE IRON TO BS EN545 K12 WHERE PIPEWORK ABOVE Ø150mm. Area of Cockloft Structure 1 = 690 sq.m. Area of High Bay Window (H.B.W.) = 2.0m(H) x 22m(total length) = 44 sq.m. 1.4 ALL DRAIN PIPES SHALL BE DISCHARGED TO A CONSPICUOUS POSITION WITHOUT THE POSSIBILITY OF BEING SUBMERGED. Total openable window area = 130 sq.m. = 6.37% of floor area 1.5 ALL PUDDLE FLANGES SHALL BE MADE OF DUCTILE IRON 1.6 SMOKE EXTRACTION SYSTEM(S) SHALL NOT BE PROVIDED AS THE AGGREGATE AREA OF OPERABLE WINDOW OF STRUCTURE 1 EXCEEDS 6.25% OF THE FLOOR AREA OF THE COMPARTMENT. 1.7 VENTILATION/AIR CONDITIONING SYSTEM NOT TO BE PROVIDED. 12000 2. HOSE REEL SYSTEM 135000 LIT. RCC Cockloft 2.1 NEW FIRE HOSE REEL SHALL BE PROVIDED AS INDICATED ON PLAN TO ENSURE THAT EVERY PART OF THE BUILDING CAN BE REACHED BY A LENGTH OF NOT MORE THAN 30m HOSE REEL TUBING. SPRINKLER WATER TANK (UNDER GROUND) 2.2 THE WATER SUPPLY FOR HOSE REEL SYSTEM WILL BE FED FROM A NEW 2m3 F.S. FIBREGLASS WATER TANK VIA TWO HOSE REEL PUMPS (DUTY/ 10m wide STANDBY) LOCATED INSIDE FS PUMP ROOM AT EXTERNAL AREA. Water Tank Ingress/Egress 2.3 HOSE REEL PUMPS SHALL BE STARTED BY ACTUATION OF ANY BREAKGLASS UNIT FITTED ASIDE EACH HOSE REEL SETS Room For FSIs Pump Room For FSIs 2.4 ALL FIRE HOSE REEL OUTLETS SHOULD BE HOUSED IN GLASS FRONTED CABINET SECURED UNDER LOCK & KEY. 2.5 ALL FIRE HOSE REEL SHOULD BE PROVIDED WITH FSD APPROVED TYPE INSTRUCTION PLATE & WSD WARNING PLATE Section drawing of window opening for the structure (1) 2000 LIT. FIBREGLASS 2.6 SECONDARY ELECTRICITY SUPPLY DIRECTLY TEE OFF BEFORE CLP'S INCOMING MAIN SWITCH SHALL BE PROVIDED FOR THE FH/HR PUMPS. ø50 **/>** ø50 ø50 SPRINKLER INLET 3. AUTOMATIC SPRINKLER SYSTEM ø50 ø50 **ø**50 3.1 NEW AUTOMATIC SPRINKLER SYSTEM SHALL BE PROVIDED AND INSTALLED IN ACCORDANCE WITH LPC RULES FOR AUTOMATIC SPRINKLER INSTALLATIONS INCORPORATING BS EN 12845: 2015 (INCLUDING TECHNICAL BULLETINS, NOTES, COMMENTAR AND RECOMMENDATIONS) AND FSD CIRCULAR LETTER HR NO. 5/2020. THE CLASSIFICATION OF THE OCCUPANCIES WILL BE ORDINARY HAZARD GROUP III. 3.2 ONE NEW 135m³ SPRINKLER WATER TANK WILL BE PROVIDED AS INDICATED ON PLAN. THE TOWN MAIN WATER SUPPLY WILL BE FED FROM SINGLE END. 3.3 TWO NEW SPRINKLER PUMPS (DUTY/STANDBY) AND ONE JOCKEY PUMP SHALL BE PROVIDED IN FS PUMP ROOM LOCATED AT EXTERNAL AREA. SPRINKLER CONTROL VALVE SET FIRE EXTINGUISHER 3.4 NEW SPRINKLER CONTROL VALVE SET AND SPRINKLER INLET SHALL BE PROVIDED AS INDICATED ON PLAN. Ø50 WATER SUPPLY PIPE 3.5 A TEST VALVE SHALL BE PROVIDED FOR EACH ZONE OF SPRINKLER PIPE. THIS VALVE SHALL BE AT A CONSPICUOUS POSITION THAT WATER CAN BE DRAINED AWAY EASILY. 3.6 ALL SUBSIDIARY STOP VALVES TO BE ELECTRIC MONITORING TYPE. 3.7 ALL ELECTRIC TYPE VALVES SHOULD GIVE VISUAL SIGNALS TO FIRE SERVICE MAIN SUPERVISORY CONTROL PANEL TO INDICATE THE STATUS (OPEN/CLOSE) OF THE VALVES. 3.8 SECONDARY ELECTRICITY SUPPLY DIRECTLY TEE OFF BEFORE CLP'S INCOMING MAIN SWITCH SHALL BE PROVIDED FOR THE SPRINKLER PUMPS. 3.9 THE SPRINKLER SYSTEM DESIGN IS BASED ON THE FOLLOWINGS: HAZARD CLASS: ORDINARY HAZARD GROUP III TYPE OF STORAGE: POST-PALLET (ST2) STORAGE CATEGORY: CATEGORY I MAXIMUM STORAGE HIEGHT: 3.5m SPRINKLER PROTECTION: CEILING PROTECTION ONLY MAXIMUM STORAGE AREA: 50m² MINIMUM CLEARANCE AROUND : 2.4m 4. FIRE ALARM SYSTEM 4.1 NEW FIRE ALARM SYSTEM SHALL BE PROVIDED IN ACCORDANCE WITH BS 5839 PART 1: 2017 AND FSD CIRCULAR LETTERS 6/2021. 12000 12000 4.2 NEW BREAKGLASS UNITS AND FIRE ALARM BELLS SHALL BE PROVIDED AT ALL NEW FIRE HOSE REEL POINTS. THE FIRE ALARM INTALLATION WILL BE INTEGRATED WITH THE HOSE REEL SYSTEM. 5. EMERGENCY LIGHTING 5.1 EMERGENCY LIGHTING SHALL BE PROVIDED IN ACCORDANCE WITH 'BS 5266-PART 1:2016 AND BS EN 1838:2013", AND FSD CIRCULAR LETTER 4/2021, COVERING ALL AREA. EMERGENCY LIGHTINGS SHALL BE BACKED UP BY BUILT-IN BATTERY AND CAPABLE OF MAINTAINING FUNCTION OF NOT LESS THAN 2 HOURS IN CASE OF POWER FAILURE 6.1 ALL EXIT SIGNS/DIRECTIONAL EXIT SIGNS SHALL BE PROVIDED IN ACCORDANCE WITH 'BS 5266-PART 1:2011 AND FSD CIRCULAR LETTER NO. 5/2008, **G/F PLAN** Section drawing of window opening for the structure (1) 構築物(1) FOR THE BUILDING. EXIT SIGNS/DIRECTIONAL EXIT SIGNS SHALL BE BACKED UP BY BUILT-IN BATTERY AND CAPABLE OF MAINTAINING FUNCTION OF NOT LESS THAN 2 HOURS IN CASE OF POWER FAILURE. 用途:可循環再造物料回收中心 構築物(3) 構築物(2) (電器、電子零件及電池)連附 7. PORTABLE APPLIANCES 7.1 PORTABLE HAND OPERATED APPLIANCES SHALL BE PROVIDED AS INDICATED ON PLAN. 用途:儲物室 用途:雨水簷篷 屬塑膠破碎工場、洗手間、辦公室 建築物料:以金屬搭建 建築物料:以金屬搭建 建築物料:以金屬搭建 LEGEND HR HOSE REEL 5KG DRY POWDER FIRE EXTINGUISHER EMERGENCY LIGHT 高度:約6米 高度:約3米 高度:約8米 FIRE EXTINGUISHER 層數:**1**層 層數:1層 層數:1層 BREAK GLASS UNIT EXIT SIGN ----- SPRINKLER HEAD (ON PLAN) SPRINKLER CONTROL VALVE SET 面積:約10平方米 面積:約290平方米 面積:約2000平方米 FIRE ALARM BELL 總樓面面積:約2285平方米 總樓面面積:約290平方米 總樓面面積:約10平方米 SPRINKLER INLET PUMP SET FIRE SERVICE CONTRACTOR DRAWING TITLE : ARCHITECT CONSULTANT PROJECT DRAWING NO REV. DATE NAME **FS-01** 可循環再造物料回收中心 F.S. Notes, Legend, C.K.NG 7 FEB 2025 DRAWN BY **Century Fire Service** Fire Service Installation SCALE : 1:300@(A1) **Engineering Co., Ltd.** CHECKED BY **Layout Plan** B.O.O. Ref. BD APPROVED BY F.S.D. Ref. FP REV DESCRIPTION DATE