To: Director of Fire Services

(Attn: Building Improvement Division) * 1 / 2

Fire Service Installation Plans for *Composite Building / Domestic Building at

Temporary Social (Nelfare Facility CDrug Dependent Persons

Treatment and Rehabilitation) for a Period of 3 years in "Recreation"

Zone, First Floor, Lot 4620 in D.D. 104, Mai Po, Yuen Long

CApplication No. A/YL-MP/327) 372

This is to certify that the details and specifications of all installations shown on the attached fire service installation plans are as prescribed by the Fire Services Department under the Fire Safety (Buildings) Ordinance and in accordance with the relevant Rules and Codes of Practices, as may be applicable, e.g.:-

- * Rules of Loss Prevention Council for Automatic Sprinkler Installation
- * Fire Offices' Committee for Automatic Sprinkler Installation (29th Edition)
- Code of Practice for Minimum Fire Service Installations and Equipment,
 Fire Services Department

Full Name of	FSI *Contractor/ Consultant :	-		
Contact Perso	on :			
Address :				
Tel.:				
Signed :		Date :	22-1-2	025

* To be deleted as appropriate

F.S. NOTES

SPRINKLER SYSTEM

- SINCE THE TOTAL AREAS OF THIS LICENSE APPLICATION IS NOT EXCEEDING 230 SQUARE METER. SPRINKLER SYSTEM SHALL NOT BE PROVIDED. FIRE ALARM SYSTEM
- FIRE ALARM SYSTEM SHALL BE BE PROVIDED IN ACCORDANCE WITH BS 5839-1:2017 AND THE FSD CIRCULAR LETTER NO. 6/2021.
- A MANUALLY OPERATED FIRE ALARM SYSTEM SHALL BE PROVIDED FOR LICENSE AREA OF ENTRANCE.

VISUAL FIRE ALARM SYSTEM

- VISUAL FIRE ALARMS SHALL BE PROVIDED IN ACCORDANCE WITH BS 5839-1:2007, THE FSD CIRCULAR LETTER NO. 2/2012 AND FOLLOW THE DESIGN MANUAL: BARRIER FREE ACCESS 2008 PUBLISHED BY THE BUILDINGS DEPARTMENT.
- VISUAL FIRE ALARM TO BE PROVIDED AND BE LOCATED AT A PROMINENT LOCATION IN PLACES WHICH ARE INTENDED TO BE ACCESSIBLE TO THE PUBLIC.
- HOSE REEL SYSTEM SHALL BE PROVIDED IN ACCORDANCE WITH THE CODE OF PRACTICE FOR MINIMUM FIRE SERVICE INSTALLATIONS AND EQUIPMENT 6.
- HOSE REEL SYSTEM SHALL BE PROVIDED FOR WHOLE BUILDING.
- THERE ARE SUFFICIENT HOSE REEL TO ENSURE THAT EVERY PART OF THE BUILDING CAN BE REACHED BY A LENGTH OF NOT MORE THAN 30M OF HOSE
- HOSE REEL PUMPS (ON DUTY AND STANDBY) SHALL BE PROVIDED FOR HOSE REEL SYSTEM.
- A 2000 LITERS HOSE REEL WATER TANK SHALL BE PROVIDED TO SERVE HOSE REEL SYSTEM.

EMERGENCY LIGHTING

- EMERGENCY LIGHTING SHALL BE PROVIDED IN ACCORDANCE WITH BS 5266-1:2016, BS EN 1838:2013 AND THE FSD CIRCULAR LETTER NO. 4/2021.
- EMERGENCY LIGHTING SHALL BE PROVIDED IN EVERY COMPARTMENT OF EACH STRUCTURE.

EXIT SIGN AND DIRECTIONAL SIGN

- SUFFICIENT EXIT SIGN AND DIRECTIONAL SIGN SHALL BE PROVIDED IN ACCORDANCE WITH BS 5839-1:2017 AND THE FSD CIRCULAR LETTER NO. 5/2008.
- 15. SUFFICIENT EXIT SIGN AND DIRECTIONAL SIGN SHALL BE PROVIDED TO ENSURE THAT ALL EXIT ROUTES AREA CLEARLY INDICATED.

POTABLE EQUIPMENT

16. PORTABLE FIRE EXTINGUISHERS SHALL BE PROVIDED AT E POSITION AS SHOWN ON PLANS.


FIRE DETECTION SYSTEM

- 17. FIRE DETECTION SYSTEM SHALL BE PROVIDED IN ACCORDANCE WITH BS 5839-1:2017 AND THE FSD CIRCULAR LETTER NO. 6/2021.
- SMOKE DETECTOR WITH SOUNDER BASE SHALL BE PROVIDED IN SLEEPING ACCOMMODATION OF LICENSE AREA.
- THE DETECTOR SHALL BE OF FSD APPROVED TYPE.
- ON MAIN FIRE ALARM CONTROL PANEL SHALL BE PROVIDED AS INDICATED ON PLANS TO RECEIVE ALL FIRE ALARM SIGNALS.
- HEAT DETECTOR SHALL BE PROVIDED FOR LAVATORY AND SMOKE DETECTOR SHALL BE PROVIDED FOR LIVING ROOM AND CORRIDOR.
- ALL FIRE ALARM SIGNALS INCLUDED FIRE DETECTORS, MANUAL FIRE ALARM CALL POINT SHALL BE LINKED TO FSD COMMUNICATION CENTRE VIA. DIRECT LINE PROVIDED BY THE AUTHORIZED SERVICE SERVICE PROVIDER OF THE COMPUTERIZED FIRE ALARM TRANSMISSION SYSTEM.

LEGEND

	LICENSE AREA	P/THR	FIRE HOSE REEL	OFE1	SKG DRY POWDER FIRE EXTINGUISHER
(S)	SMOKE DETECTOR	×	GATE VALVE	O _{FE2}	9L WATER TYPE FIRE EXTINGUISHER
(S) _{SB}	SMOKE DETECTOR WITH SOUNDER BASE	. N	CHECK VALVE	OFES	5KG CO2 GAS TYPE FIRE EXTINGUISHER
	HEAT DETECTOR	bril	FLEXIBLE CONNECTOR	[EXIT]	EXIT SIGN BOX
×	REMOTE INDICATION LAMP	19	Y-TYPE STRAINER	(E	DIRECTIONAL SIGN BOX
)o,W	REMOTE INDICATION LAMP (WEATHERPROOF TYPE)	0-	BALL FLOAT VALVE	Ð	FIRE ALARM BELL
V	VISUAL FIRE ALARM		STRAINER	AFA QQ	MASTER FIRE ALARM BELL
	EMERGENCY LIGHTING WITH BACK UP BATTERY		CHECK METER POSITION		MONITOR MODULE

PROJECT:

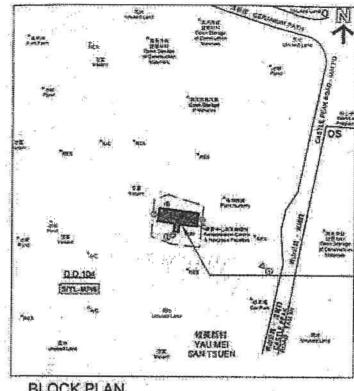

元朗米埔丈量約份 第104約地段 第4620號1樓 FIRST FLOOR, LOT 4620 IN D.D. 104, MAI PO, YUEN LONG

BLOCK PLAN

TIA

ABBREVIATION

LAL.	LOW LEVEL	F.E.	FIRE EXTINGUISHER
H/L	HIGH LEVEL	F.S	FIRE SERVICES
	* Historia Constitution	S.S.	STAINLESS STEEL
FSD	FIRE SERVICES DEPARTMENT	HR	HOSE REEL
WSD	WATER SUPPLIES DEPARTMENT	W	TEST STREET IN THE PA
COP	CODE OF PRACTICE	A.A.V.	AITOMATIC AIR VEN

T/B	TO BELOW
FIA	FROM ABOVE
19	•

TO ABOVE

)je		COLOUR CO	<u>DDE</u>
Ø B¥	PRESSURE GAUGE CAV BALL VALVE	FOR PIPE S	SIZES:
P	PRESSURE SWITCH	PIPE SIZE	COLOUR CODE
AVZS	AUTOMATIC AIR VENT	25mm diameter 40mm diameter	GREEN ———————————————————————————————————
T	LEVEL FLOAT SWITCH	50mm diameter	YELLOW -

18
MANUAL FIRE ALARM CALL POINT
F.S. CONTROL PANEL

HOSE REEL PUMP

	8
C	CONTROL MODULE

2024/6/24

FSI CONTRACTOR:



WING KAI ENG. CO. No. 8, 7/F., Kingsford Industrial Centre, 13 Wang Hoi Road, Kowloon Bay, Kin Tel:27561722 Fax:27951775

MISSION ARK LTD.

CLIENT:


元朗米埔丈量約份 第104約地段 第4620號1樓 關臨時社會福利設施藥物倚賴者治療及康復中心) F.S. NOTES, LEGEND, BLOCK PLAN, ABBREVIATION AND COLOUR CODE FOR PIPE SIZES


TITLE:

R3	REVISED	06/2024		SCALE:	JOB NO.:
R2	REVISED	12/2023		DRAWN: CAD	WK230927
R1	REVISED	09/2023		CHECKED: CK HO	DRAWING NO.:
NO.	REVISIONS	DATE:	BY	DATE:	FS-01




DETAIL OF HOSE REEL OPERATION INSTRUCTION PLATE

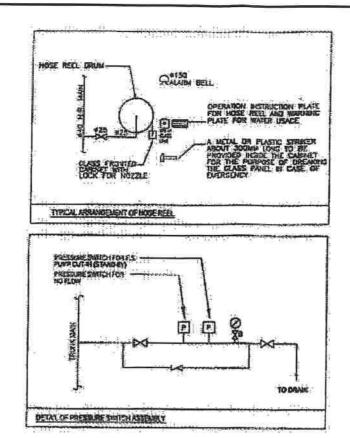

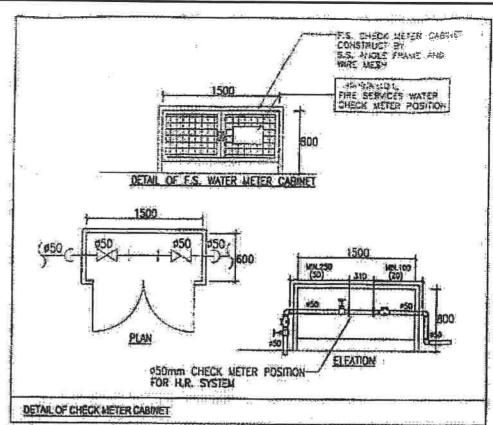

FS PUMP SCHEDULE

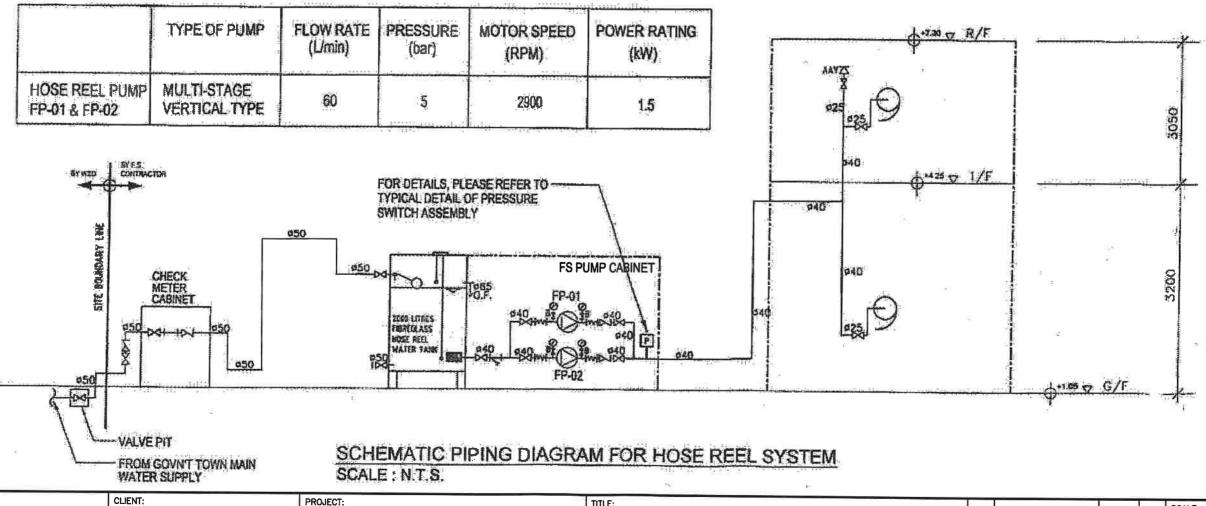

FSI CONTRACTOR:



WING KAI ENG. CO. No. 8, 7/F., Kingsford Industrial Centre, 13 Wang Hoi Road, Kowloon Bay, Kin

Tel:27561722 Fax:27951775


MISSION ARK LTD.

PROJECT:

元朗米埔丈量約份 第104約地段 第4620號1樓 關臨時社會福利設施藥物倚賴者治療及康復中心) TITLE:

SCHEMATIC PIPING DIAGRAM FOR HOSE REEL SYSTEM AND PUMP SCHEDULE

R3	REVISED	06/2024		SCALE:	JOB NO.:
R2	REVISED	12/2023		DRAWN: CAD	WK230927
R1	REVISED	09/2023		CHECKED: CK HO	DRAWING NO.:
NO.	REVISIONS	DATE:	BY	DATE:	FS-02

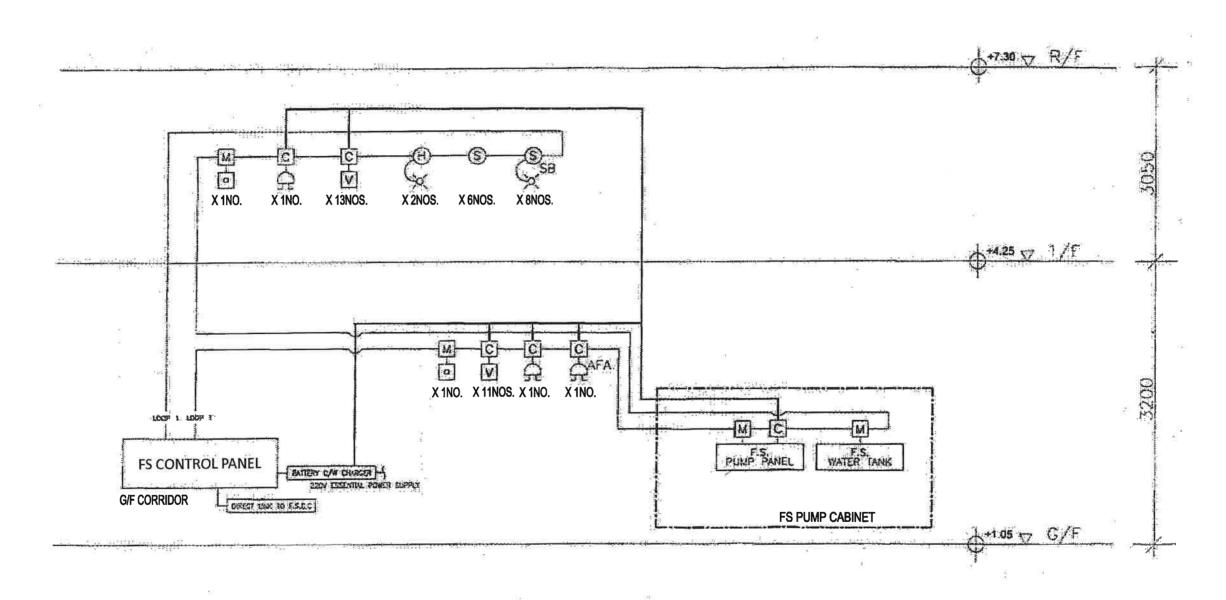

SCHEMATIC CONTROL WIRING DIAGRAM FOR FIRE ALARM SYSTEM SCALE: N.T.S.

FSI CONTRACTOR:

FIRE PROTECTION
WING KAI

WING KAI ENG. CO.
No. 8, 7/F., Kingsford Industrial Centre,
13 Wang Hoi Road, Kowloon Bay, Kln
Tel:27561722 Fax:27951775

CLIENTS


MISSION ARK LTD.


元朗米埔丈量約份 第104約地段 第4620號1樓 (闢臨時社會福利設施藥物倚賴者治療及康復中心)

PROJECT:

SCHEMATIC CONTROL WIRING DIAGRAM FOR FIRE ALARM SYSTEM

JOB NO.: REVISED 06/2024 WK230927 DRAWN: R2 12/2023 REVISED CHECKED: DRAWING NO .: 09/2023 REVISED FS-03 DATE: REVISIONS DATE:

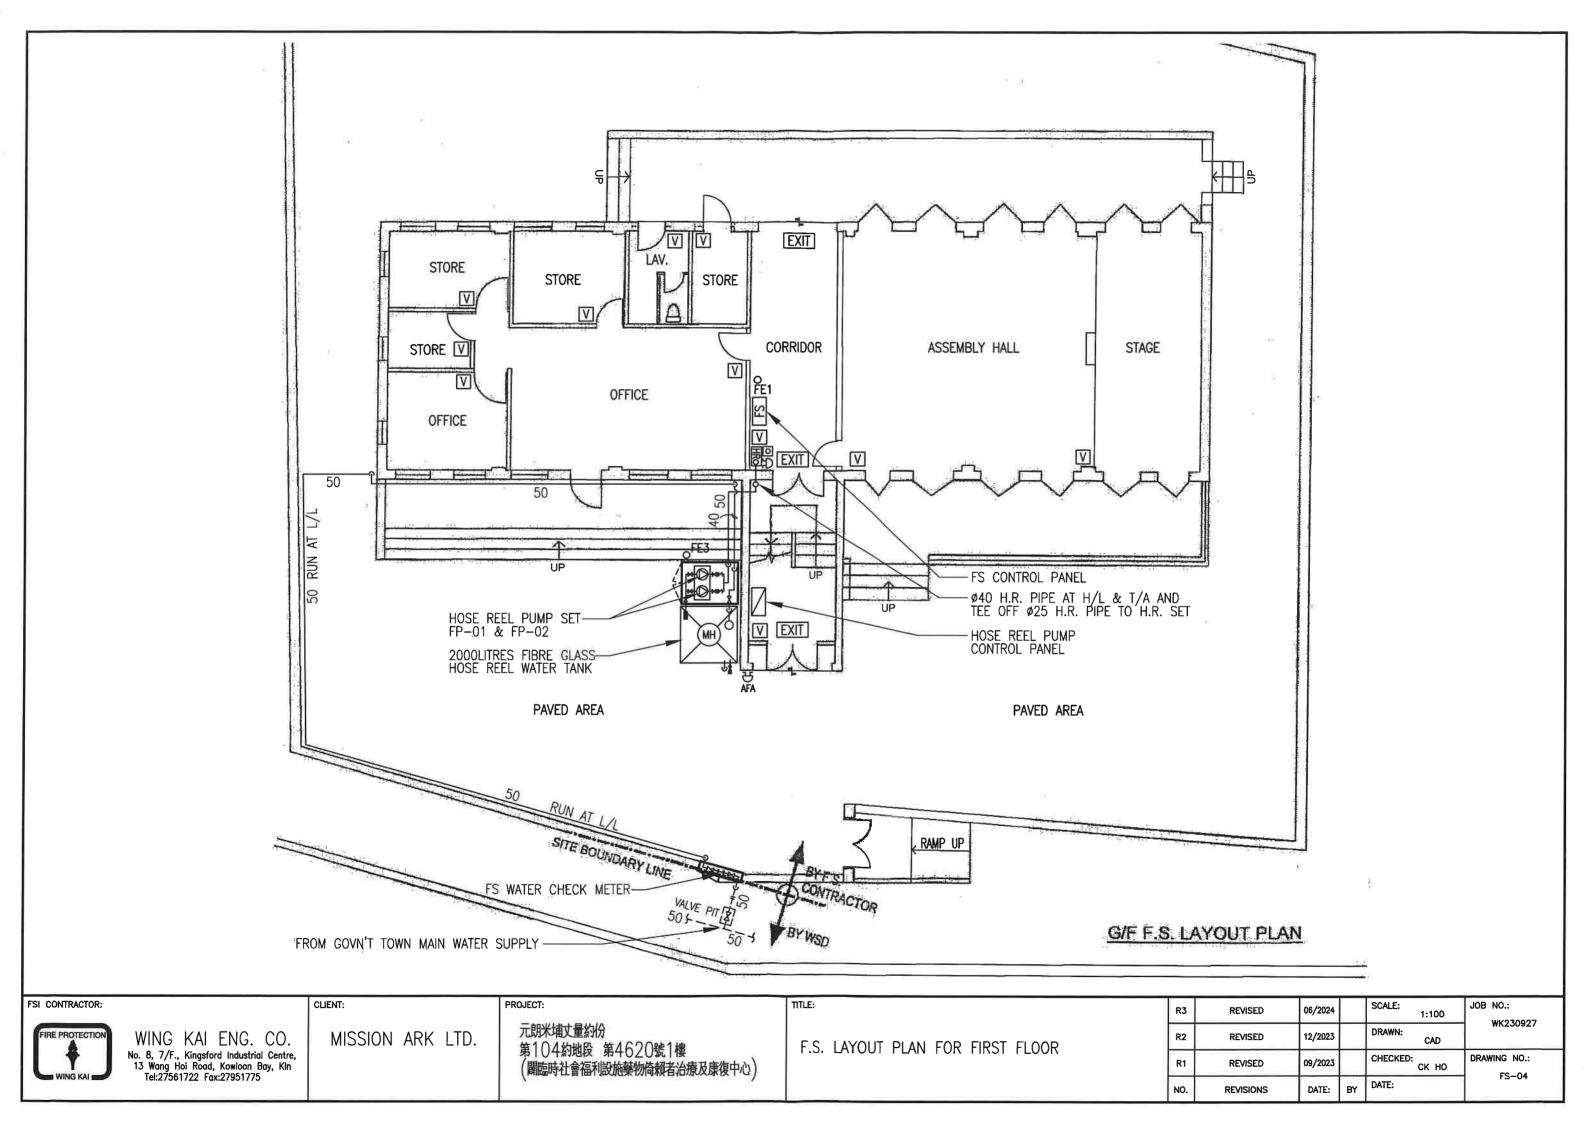

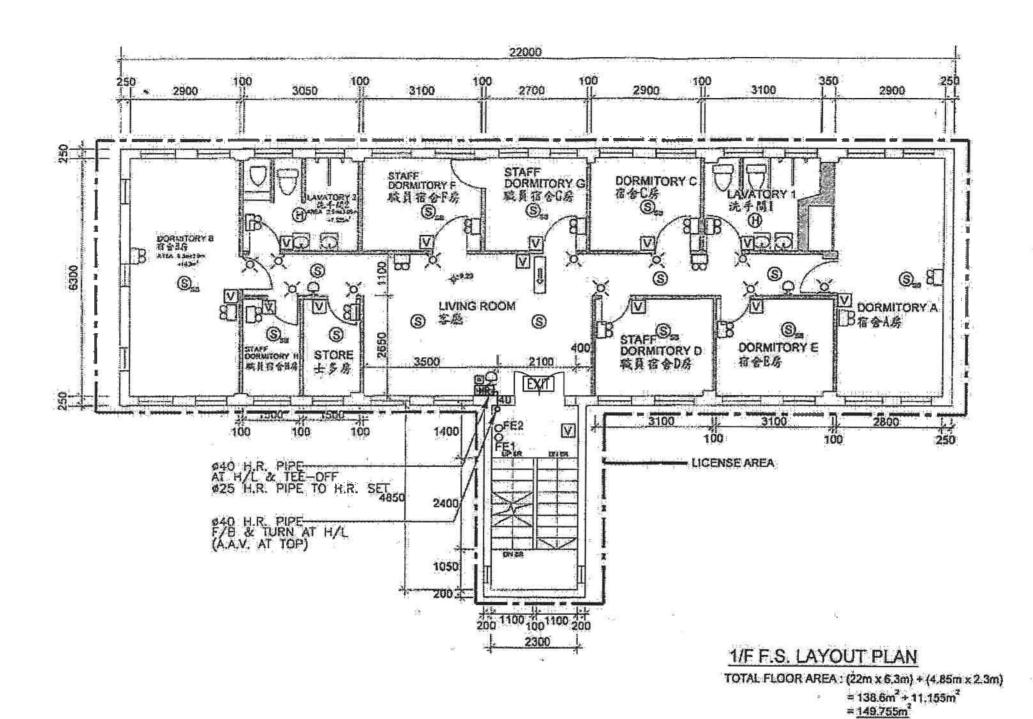

CONCLUSION, TOTAL LICENSE FLOOR AREA IS 149.755m, WHICH IS LESS THAN 230m²

WHICH IS LESS THAN 230m²,
THEREFOR NO SPRINKLER SYSTEM IS REQUIRED.

FSI CONTRACTOR:



WING KAI ENG. CO.
No. 8, 7/F., Kingsford Industrial Centre,
13 Wang Hoi Road, Kowloon Bay, Kin
Tel:27561722 Fax:27951775

CLIENT:

MISSION ARK LTD.

PROJECT:

元朗米埔丈量約份
第104約地段 第4620號1樓
(關臨時社會福利設施藥物倚賴者治療及康復中心)

TITLE:

F.S. LAYOUT PLAN FOR FIRST FLOOR

R3	REVISED REVISED	06/2024		SCALE: 1:100 DRAWN: CAD	JOB NO.: WK230927
R1	REVISED	09/2023		CHECKED: CK HO	DRAWING NO.:
NO.	REVISIONS	DATE:	BY	DATE:	FS-05