For Official Use Only 請勿填寫此欄	Application No. 申請編號	
	Date Received 收到日期	

- 1. The completed form and supporting documents (if any) should be sent to the Secretary, Town Planning Board (the Board), 15/F, North Point Government Offices, 333 Java Road, North Point, Hong Kong. 申請人須把填妥的申請表格及其他支持申請的文件 (倘有),送交香港北角渣華道 333 號北角政府合署 15 樓城市規劃委員會(下稱「委員會」)秘書收。
- 2. Please read the "Guidance Notes" carefully before you fill in this form. The document can be downloaded from the Board's website at <a href="http://www.tpb.gov.hk/">http://www.tpb.gov.hk/</a>. It can also be obtained from the Secretariat of the Board at 15/F, North Point Government Offices, 333 Java Road, North Point, Hong Kong (Tel: 2231 4810 or 2231 4835), and the Planning Enquiry Counters of the Planning Department (Hotline: 2231 5000) (17/F, North Point Government Offices, 333 Java Road, North Point, Hong Kong and 14/F, Sha Tin Government Offices, 1 Sheung Wo Che Road, Sha Tin, New Territories). 請先細閱《申請須知》的資料單張,然後填寫此表格。該份文件可從委員會的網頁下載(網址: <a href="http://www.tpb.gov.hk/">http://www.tpb.gov.hk/</a>),亦可向委員會秘書處(香港北角渣華道 333 號北角政府合署 15 樓-電話:2231 4810 或 2231 4835)及規劃署的規劃資料查詢處(熱線:2231 5000) (香港北角渣華道 333 號北角政府合署 17 樓及新界沙田上禾輋路 1 號沙田政府合署 14 樓)索取。
- 3. This form can be downloaded from the Board's website, and obtained from the Secretariat of the Board and the Planning Enquiry Counters of the Planning Department. The form should be typed or completed in block letters. The processing of the application may be refused if the required information or the required copies are incomplete. 此表格可從委員會的網頁下載,亦可向委員會秘書處及規劃署的規劃資料查詢處索取。申請人須以打印方式或以正楷填寫表格。如果申請人所提交的資料或文件副本不齊全,委員會可拒絕處理有關申請。

1.	Name of Applicant	申請人姓名/名稱
----	-------------------	----------

(☑Mr. 先生 /□Mrs. 夫人 /□Miss 小姐 /□Ms. 女士 /□Company 公司 /□Organisation 機構 )

TANG Shing Chun 鄧丞峻

2. Name of Authorised Agent (if applicable) 獲授權代理人姓名/名稱(如適用)

(□Mr. 先生 /□Mrs. 夫人 /□Miss 小姐 /□Ms. 女士 / ☑ Company 公司 /□Organisation 機構 )

3.	Application Site 申請地點	
(a)	Full address / location / demarcation district and lot number (if applicable) 詳細地址/地點/丈量約份及地段號碼(如適用)	Lot 55 (Part) in D.D. 108, Pat Heung, Yuen Long, New Territories
(b)	Site area and/or gross floor area involved 涉及的地盤面積及/或總樓面面 積	☑Site area 地盤面積 2,650 sq.m 平方米☑About 約 ☑Gross floor area 總樓面面積 183 sq.m 平方米☑About 約
(c)	Area of Government land included (if any) 所包括的政府土地面積(倘有)	NA sq.m 平方米 □About 約

6. Type(s) of Applicatio	n 申請類別	Ŋ				
(A) Temporary Use/Development of Land and/or Building Not Exceeding 3 Years in Rural Areas or Regulated Areas 位於鄉郊地區或受規管地區土地上及/或建築物內進行為期不超過三年的臨時用途/發展 (For Renewal of Permission for Temporary Use or Development in Rural Areas or Regulated Areas, please proceed to Part (B)) (如屬位於鄉郊地區或受規管地區臨時用途/發展的規劃許可續期,請填寫(B)部分)						
(如屬似於鄉外地區以受物	·官心區臨時用於 	並/發展的規劃計	'円續期', 調	(B)部分)		
(a) Proposed use(s)/development 擬議用途/發展  Temporary Open Storage of Construction Materials and Machineries with Ancillary Facilities for a Period of 3 Years and Associated Filling of Land						
				plan) (請用平面圖該 3	記明擬議詳情)	
(b) Effective period of permission applied for 申請的許可有效期		ear(s) 年 onth(s) 個月				
(c) Development Schedule 發展	<u>細節表</u>					
Proposed uncovered land are	a 擬議露天土地	面積		2,467	…sq.m 🗹 About 約	
Proposed covered land area	疑議有上蓋土地	面積		183	sq.m 🗹 About 約	
Proposed number of building	s/structures 擬議	建築物/構築物	」數目	3	•••	
Proposed domestic floor area	擬議住用樓面面	面積			sq.m □About 約	
Proposed non-domestic floor					sq.m <b>☑</b> About 約	
Proposed gross floor area 擬		ц <u>Г</u>			sq.m <b>▼</b> About 約	
Proposed height and use(s) of did 的擬議用涂 (如滴用) (Please us STRUCTURE USE		-				
B1 SITE OFFICE AND WAS B2 STORAGE OF CONSTR B3 STORAGE OF TOOLS		75 m <sup>2</sup> (ABOUT) 72 m <sup>2</sup> (ABOUT) 36 m <sup>2</sup> (ABOUT)	75 m <sup>2</sup> (ABOUT) 72 m <sup>2</sup> (ABOUT) 36 m <sup>2</sup> (ABOUT)	2.8 m (ABOUT)(1-ST0 4.8 m (ABOUT)(1-ST0 2.8 m (ABOUT)(1-ST0	DREY)	
8	TOTAL	183 m² (ABOUT)	183 m² (ABOUT)			
Proposed number of car parking		不同種類停車位	1的擬議數目			
Private Car Parking Spaces 私家	(車車位			1		
Motorcycle Parking Spaces 電罩						
Light Goods Vehicle Parking Sp						
Medium Goods Vehicle Parking Heavy Goods Vehicle Parking S	-					
Others (Please Specify) 其他 (詞	=					
Proposed number of loading/unle	pading spaces 上	落客貨車位的擬	議數目			
Taxi Spaces 的士車位						
Coach Spaces 旅遊巴車位						
Light Goods Vehicle Spaces 輕						
Medium Goods Vehicle Spaces						
Heavy Goods Vehicle Spaces 重 Others (Please Specify) 其他 (				1(Conta	iner Vehicle)	
Julers (Please Specify) 共他 (調列内)						

1 -	osed operating hours †		8:00, no operation on Sunday and public holiday	<i>(</i>
(d) Any vehicular access to the site/subject building? 是否有車路通往地盤/有關建築物?			▼ There is an existing access. (please indices appropriate) 有一條現有車路。(請註明車路名稱(如適) Accessible from Fan Kam Road via a loce There is a proposed access. (please illustrate of 有一條擬議車路。(請在圖則顯示,並註	用)) eal access on plan and specify the width)
(e)	(If necessary, please u	use separate she for not providi	疑議發展計劃的影響 ets to indicate the proposed measures to minimise pos ng such measures. 如需要的話,請另頁註明可盡量	1 0
(ii)	Does the development proposal involve alteration of existing building? 擬議發展計劃是否包括現有建築物的改動?  Does the development proposal involve the operation on the right? 擬議發展是否涉及右列的工程?		Please provide details 請提供詳情  (Please indicate on site plan the boundary of concerned land diversion, the extent of filling of land/pond(s) and/or excavation of (請用地盤平面圖顯示有關土地/池塘界線,以及河道改道、填範圍)  □ Diversion of stream 河道改道 □ Filling of pond 填塘     Area of filling 填塘面積	of land) 真塘、填土及/或挖土的細節及/或 中子米 □About 約 m 米 □About 約 平方米 □About 約 m 米 □About 約 m 米 □About 約
(iii)	Would the development proposal cause any adverse impacts? 擬議發展計劃會否造成不良影響?	Landscape Im Tree Felling Visual Impact	交通       Yes 會 lly 對供水         对排水       Yes 會 的對排水         對坡       Yes 會 的 popes 受斜坡影響         pact 構成景觀影響       Yes 會 的 yes 會 yes ө no yes yes ө no yes уез он yes ө no yes уез он yes ө no yes уез он yes он y	No 不會       ✓         No 不會       ✓

(i)	Gross floor area and/or plot ratio 總樓面面積及/或 地積比率		sq.m 平方米	Plot I	Ratio 地積比率
		Domestic 住用	□ About 約 □ Not more than 不多於		□About 約 □Not more than 不多於
		Non-domestic 非住用	■ About 約 □ Not more than 不多於	0.0	☑About 約 7 □Not more than 不多於
(ii)	No. of blocks 幢數	Domestic 住用			
		Non-domestic 非住用	3		
(iii)	Building height/No. of storeys 建築物高度/層數	Domestic 住用		□ (No	m 米 t more than 不多於)
				□ (No	Storeys(s) 層 t more than 不多於)
		I	Non-domestic 非住用	2.8 to 4.8	<b>☑</b> (No
			1	□ (No	Storeys(s) 層 t more than 不多於)
(iv)	Site coverage 上蓋面積		7	%	☑ About 約
(v)	No. of parking spaces and loading /	Total no. of vehicle	e parking spaces 停車位總數		1
	unloading spaces 停車位及上落客貨 車位數目	Motorcycle Parkii Light Goods Vehi Medium Goods V Heavy Goods Vel Others (Please Sp	ng Spaces 私家車車位 ng Spaces 電單車車位 icle Parking Spaces 輕型貨車泊車 ehicle Parking Spaces 中型貨車泊車 nicle Parking Spaces 重型貨車泊車 ecify) 其他 (請列明)	白車位	1(PC)
		上落客貨車位/ Taxi Spaces 的士 Coach Spaces 旅	主車位		1
		Medium Goods V Heavy Goods Vel	Tehicle Spaces 中型貨車位 nicle Spaces 重型貨車車位 ecify) 其他 (請列明)		1 (CV)

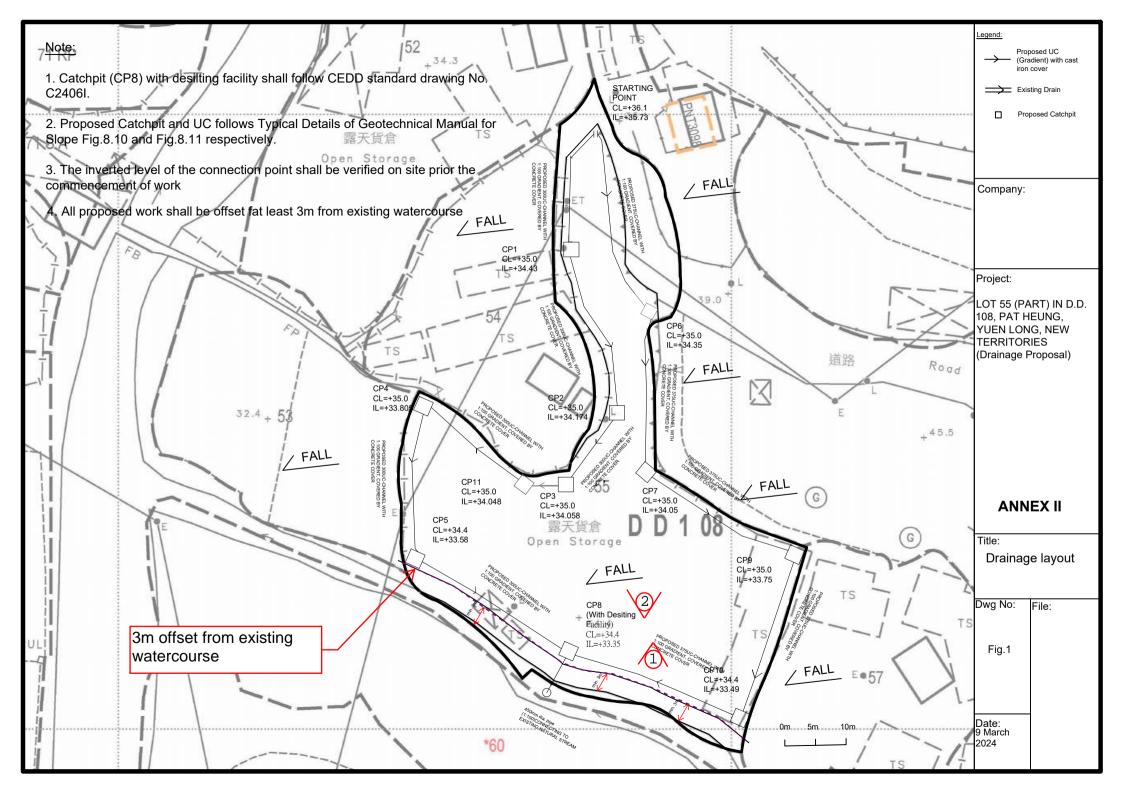




PHOTO1: EXISTING WATERCOURSE CONDITION



PHOTO 2: SITE CONDITION




PHOTO3: AERIAL PHOTO of EXISTING WATERCOURSE CONDITION





PHOTO4: Proposed site beside existing stream (offset 3m frm existing stream is clear)



PHOTO5: Proposed site beside existing stream (offset 3m frm existing stream is clear)

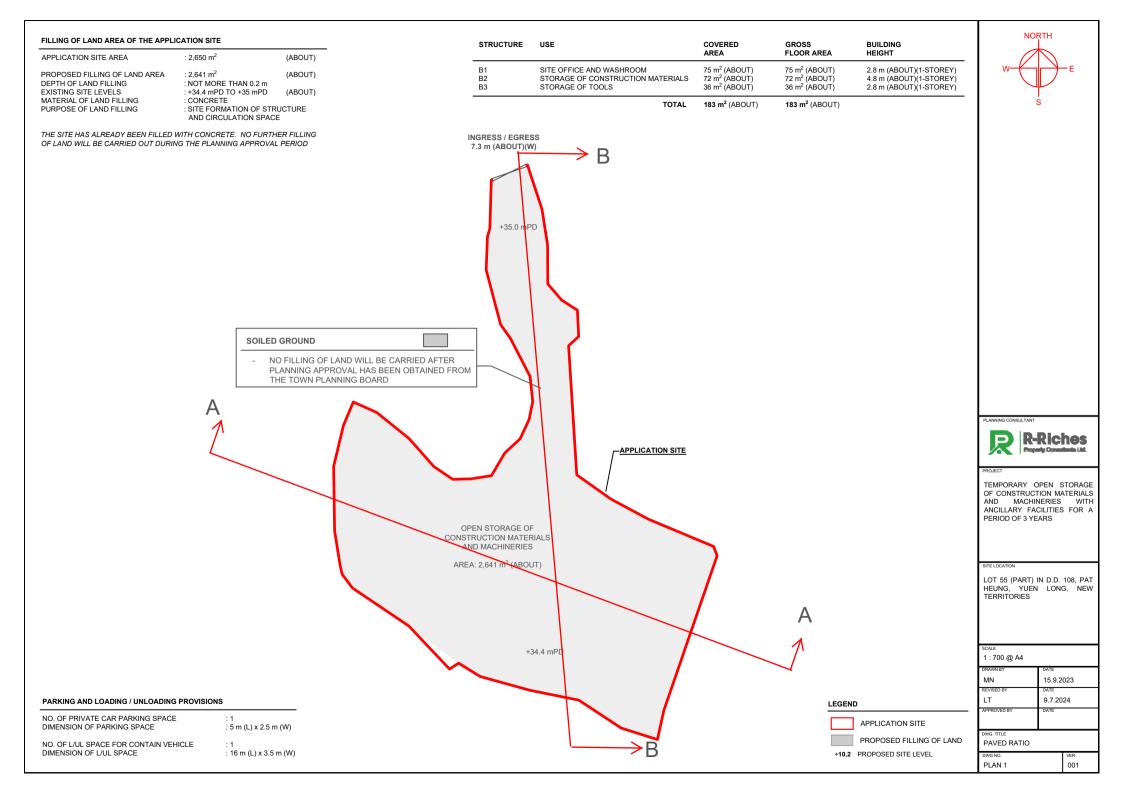

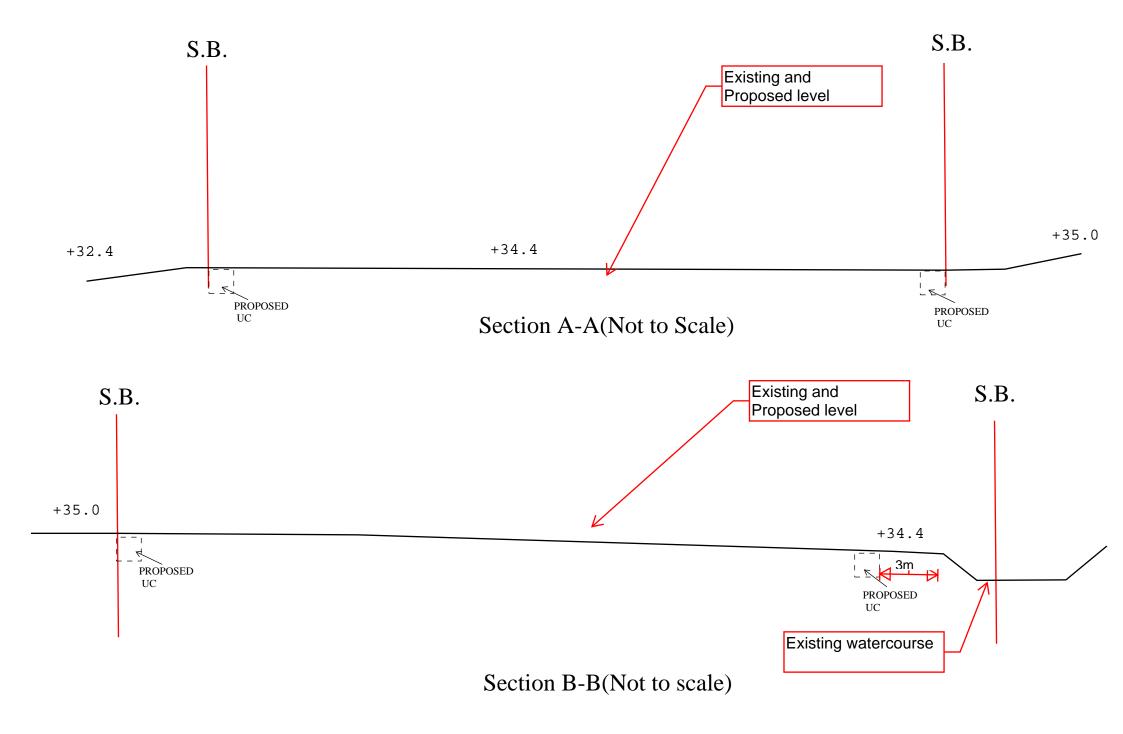

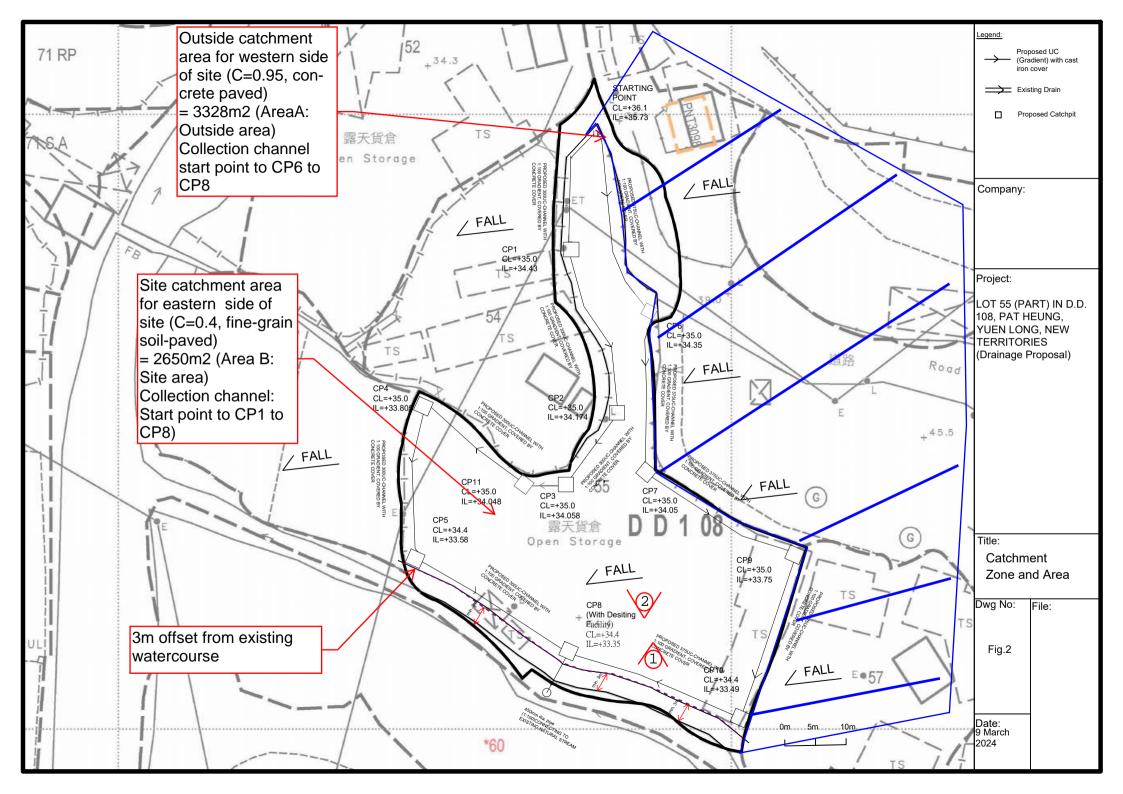

Company:

Project:

Date:

### Calculation for channels:

Catchment Area of site

Area A	= =	3328 m <sup>2</sup> 0.003328 km <sup>2</sup>
Peak runoff in m^3/s	= = =	0.278 x 0.95 x 250 mm/hr x 0.003328 km^0.2197 m^3/s 13184 liter/min
Area B	= =	2650 m^2 0.00265 km^2
Peak runoff in m^3/s	= = =	0.278 x 0.40 x 250 mm/hr x 0.00265 km^0.0737 m^3/s 4420.2 liter/min

According to (Figure 8.7 - Chart for the Rapid Design of Channels), For gradient 1:100, 375UC will be suitable for the site at the western site. For gradient 1:100, 300UC will be suitable for the site at eastern side.


Total Peak Runoff of site area = 0.293 m<sup>3</sup>/s = 17604 liter/min

Check 450mm dia. Pipe by Colebrook-White Equation

$$V = -\sqrt{(8gDs)} \log(\frac{ks}{3.7D} + \frac{2.51v}{D\sqrt{(2gDs)}})$$

where: V mean velocity (m/s) 9.81 m/s2 gravitational acceleration (m/s2) g Ď 0.45 internal pipe diameter (m) = m 0.000003 m (Table 5, from DSD Sewerage Manual, uPVC) ks hydraulic pipeline roughness (m) = 1.14E-06 m2/s kinematic viscosity of fluid (m2/s) 0.01 hydraulic gradient Therefore, design V of pipe = 2.7541 m/s > Design velocity from = 0.293 m3/s / 0.45^2 \* pi/4 catchment area = 1.840 m/s ===>O.K. capacity

Slopes Guidelines on Hydraulic Design of U-shaped and Half-round Channels on GEO Technical Guidance Note No. 43 (TGN 43)

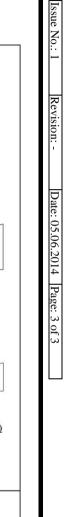



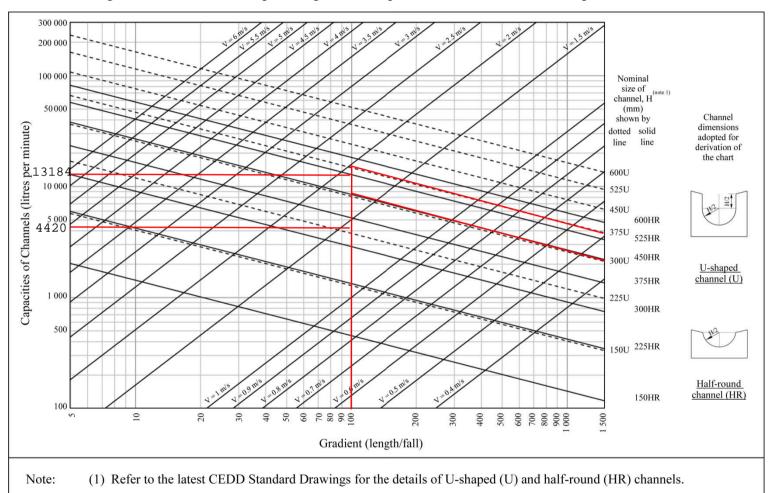



Figure 1 - Chart for the rapid design of U-shaped and half-round channels up to 600 mm


**ANNEX TGN 43 A1** 

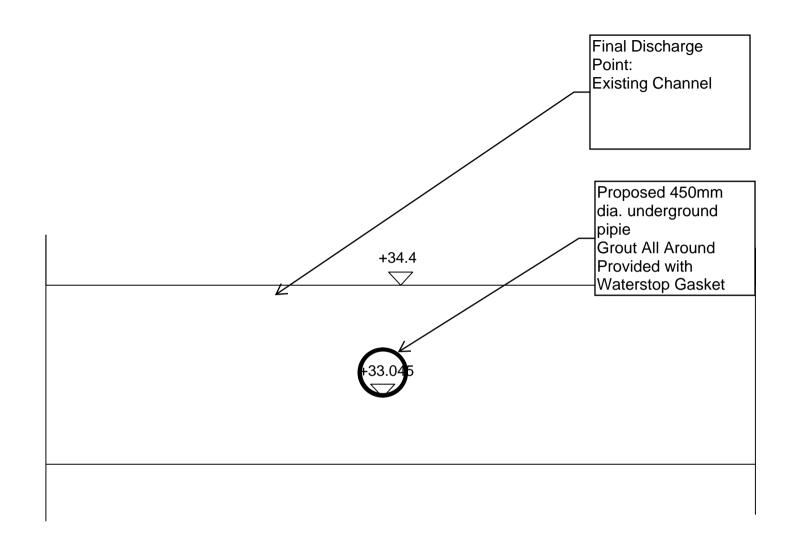

Connection Detail of Existing channel

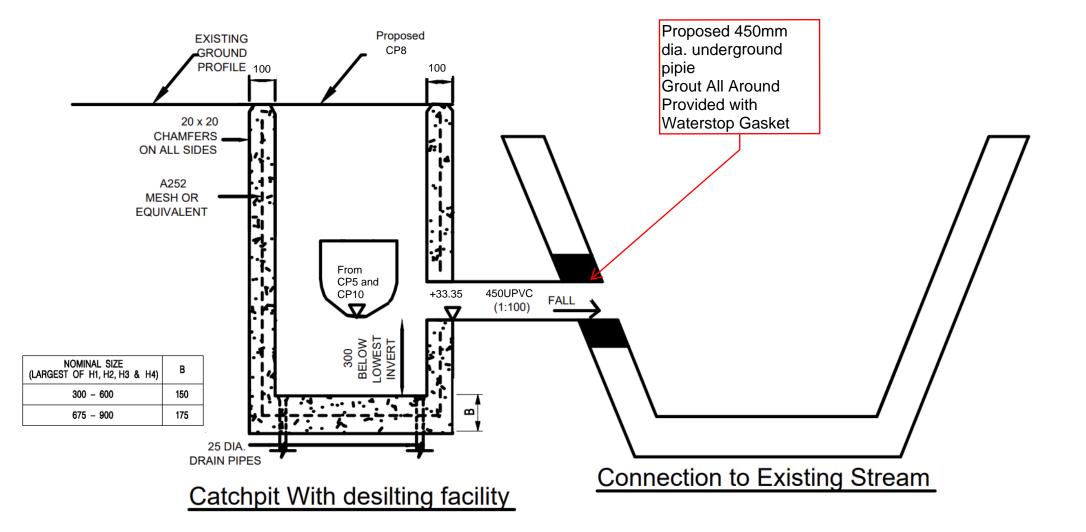

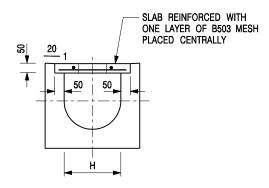

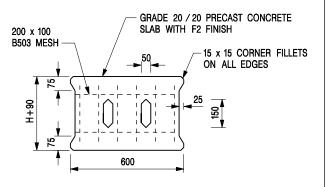



TYPICAL SECTION

PLAN OF SLAB

### U-CHANNELS WITH PRECAST CONCRETE SLABS

(UP TO H OF 525)

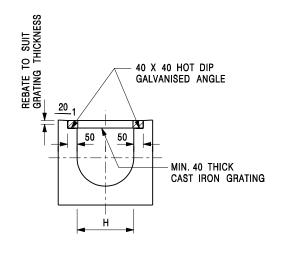

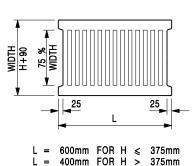

### TYPICAL SECTION

CAST IRON GRATING

(DIMENSIONS ARE FOR GUIDANCE ONLY, CONTRACTOR MAY SUBMIT EQUIVALENT TYPE)

# U-CHANNEL WITH CAST IRON GRATING

(UP TO H OF 525)

### NOTES:

- 1. ALL DIMENSIONS ARE IN MILLIMETRES.
- 2. H=NOMINAL CHANNEL SIZE.
- 3. ALL CAST IRON FOR GRATINGS SHALL BE GRADE EN-GJL-150 COMPLYING WITH BS EN 1561.
- 4. FOR COVERED CHANNELS TO BE HANDED OVER TO HIGHWAYS DEPARTMENT FOR MAINTENANCE, THE GRATING DETAILS SHALL FOLLOW THOSE AS SHOWN ON HyD STD. DRG. NO. H3156.

С	MINOR AMENDMENT. NOTE 3 ADDED.	Original Signed Original Signed	
В	NAME OF DEPARTMENT AMENDED.	Original Signed	01.2005
A	CAST IRON GRATING AMENDED.	Original Signed	12.2002

# COVER SLAB AND CAST IRON GRATING FOR CHANNELS



# CIVIL ENGINEERING AND DEVELOPMENT DEPARTMENT

 SCALE 1:20
 DRAWING NO.

 DATE JAN 1991
 C2412E

卓越工程 建設香港 We Engineer Hong Kong's Development

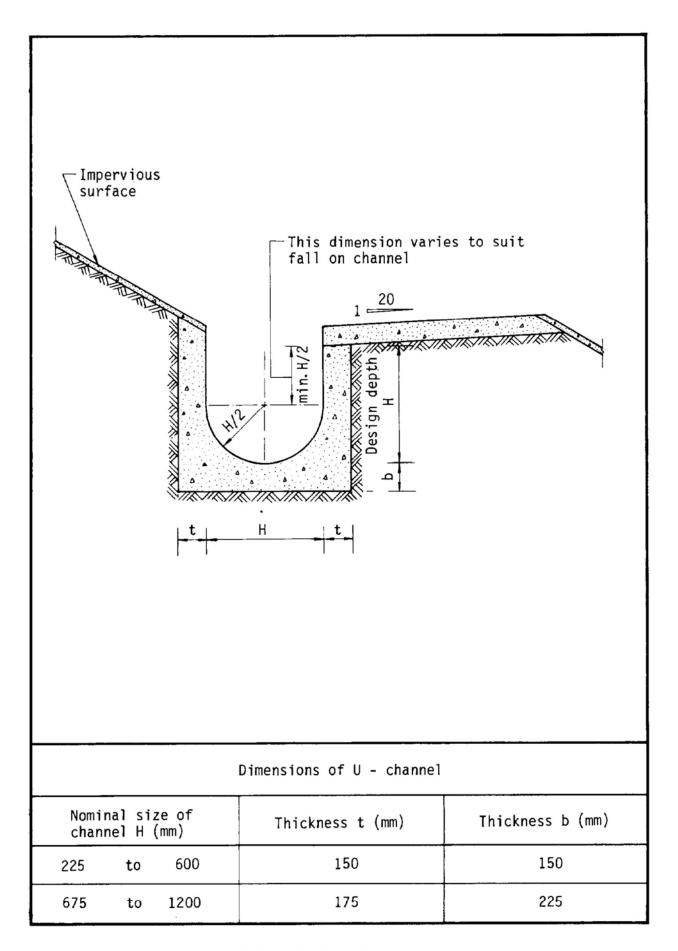


Figure 8.11 - Typical U-channel Details


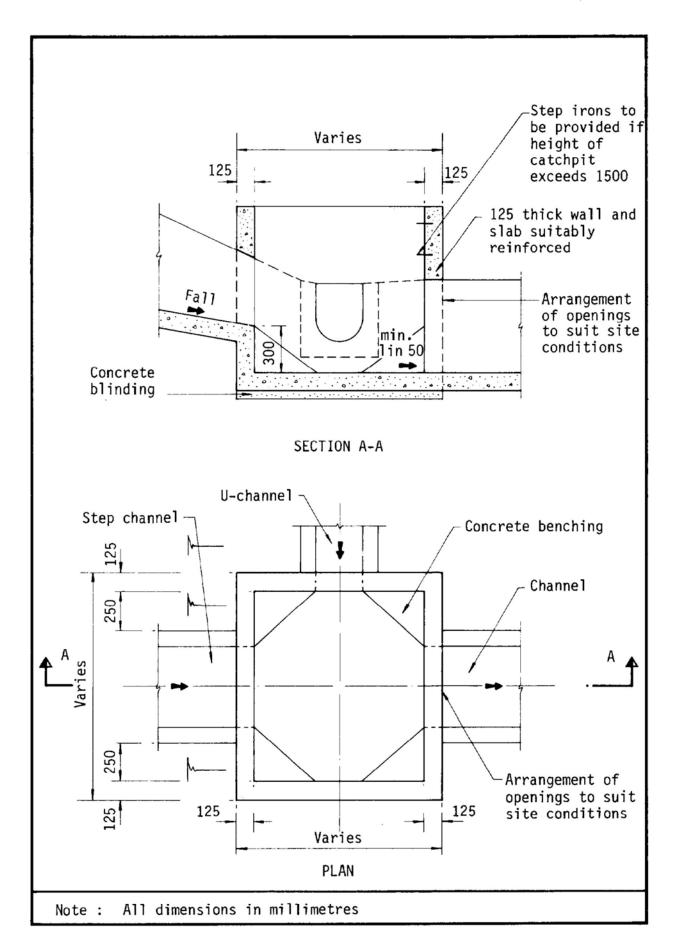


Figure 8.10 - Typical Details of Catchpits

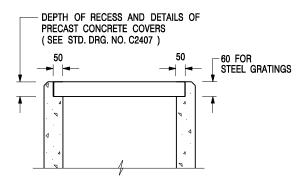

# ALTERNATIVE TOP SECTION FOR PRECAST CONCRETE COVERS / GRATINGS

### NOTES:

- 1. ALL DIMENSIONS ARE IN MILLIMETRES.
- 2. ALL CONCRETE SHALL BE GRADE 20 /20.
- 3. CONCRETE SURFACE FINISH SHALL BE CLASS U2 OR F2 AS APPROPRIATE.
- 4. FOR DETAILS OF JOINT, REFER TO STD. DRG. NO. C2413.
- 5. CONCRETE TO BE COLOURED AS SPECIFIED.
- UNLESS REQUESTED BY THE MAINTENANCE PARTY AND AS DIRECTED BY THE ENGINEER, CATCHPIT WITH TRAP IS NORMALLY NOT PREFERRED DUE TO PONDING PROBLEM.
- 7. UPON THE REQUEST FROM MAINTENANCE PARTY, DRAIN PIPES AT CATCHPIT BASE CAN BE USED BUT THIS IS FOR CATCHPITS LOCATED AT SLOPE TOE ONLY AND AS DIRECTED BY THE ENGINEER.
- FOR CATCHPITS CONSTRUCTED ON OR ADJACENT TO A FOOTPATH, STEEL GRATINGS (SEE DETAIL 'A' ON STD. DRG. NO. C2405 ) OR CONCRETE COVERS (SEE STD. DRG. NO. C2407 ) SHALL BE PROVIDED AS DIRECTED BY THE ENGINEER.
- 9. IF INSTRUCTED BY THE ENGINEER, HANDRAILING (SEE DETAIL 'G' ON STD. DRG. NO. C2405; EXCEPT ON THE UPSLOPE SIDE) IN LIEU OF STEEL GRATINGS OR CONCRETE COVERS CAN BE ACCEPTED AS AN ALTERNATIVE SAFETY MEASURE FOR CATCHPITS NOT ON A FOOTPATH NOR ADJACENT TO IT. TOP OF THE HANDRAILING SHALL BE 1 000 mm MIN. MEASURED FROM THE ADJACENT GROUND LEVEL.
- 10. MINIMUM INTERNAL CATCHPIT WIDTH SHALL BE 1 000 mm FOR CATCHPITS WITH A HEIGHT EXCEEDING 1 000 mm MEASURED FROM THE INVERT LEVEL TO THE ADJACENT GROUND LEVEL. AND, STEP IRONS (SEE DSD STD. DRG. NO. DS1043 ) AT 300 ℃ STAGGERED SHALL BE PROVIDED. THICKNESS OF CATCHPIT WALL FOR INSTALLATION OF STEP IRONS SHALL BE INCREASED TO 150 mm.
- FOR RETROFITTING AN EXISTING CATCHPIT WITH STEEL GRATING, SEE DETAIL 'F' ON STD. DRG. NO. C2405.
- SUBJECT TO THE APPROVAL OF THE ENGINEER, OTHER MATERIALS CAN ALSO BE USED AS COVERS / GRATINGS.

- FORMER DRG. NO. C2406J. Original Signed 03.2015
REF. REVISION SIGNATURE DATE

CIVIL ENGINEERING AND
DEVELOPMENT DEPARTMENT


CATCHPIT WITH TRAP (SHEET 2 OF 2)

 SCALE 1:20
 DRAWING NO.

 DATE JAN 1991
 C2406 /2

卓越工程 建設香港

We Engineer Hong Kong's Development

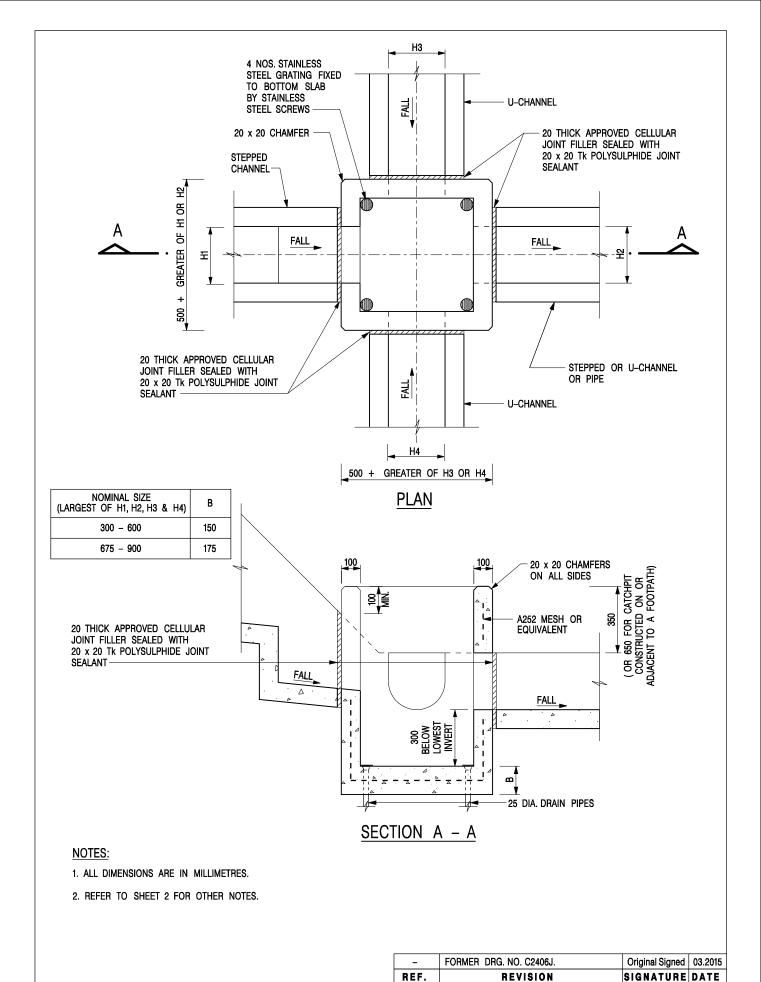

CATCHPIT WITH TRAP (SHEET 1 OF 2)

**DEVELOPMENT DEPARTMENT** SCALE 1:20 **DATE** JAN 1991

CEDD

DRAWING NO. C2406 /1

CIVIL ENGINEERING AND

卓越工程 建設香港

We Engineer Hong Kong's Development

#### DEVELOPMENT PARAMETERS

APPLICATION SITE AREA	: 2,650 m <sup>2</sup>	(ABOUT)
COVERED AREA	: 183 m <sup>2</sup>	(ABOUT)
UNCOVERED AREA	: 2,467 m <sup>2</sup>	(ABOUT)
PLOT RATIO	: 0.07	(ABOUT)
SITE COVERAGE	: 7%	(ABOUT)
NO. OF STRUCTURE DOMESTIC GFA NON-DOMESTIC GFA TOTAL GFA	: 3 : N/A : 183 m <sup>2</sup> : 183 m <sup>2</sup>	(ABOUT) (ABOUT)
BUILDING HEIGHT NO. OF STOREY	: 2.8 m - 4.8 m : 1	(ABOUT)

#### PARKING AND LOADING / UNLOADING PROVISIONS

 NO. OF PRIVATE CAR PARKING SPACE
 : 1

 DIMENSION OF PARKING SPACE
 : 5 m (L) x 2.5 m (W)

 NO. OF L/UL SPACE FOR CONTAIN VEHICLE
 : 1

 DIMENSION OF L/UL SPACE
 : 16 m (L) x 3.5 m (W)

FIRE SERVICE INSTALLATIONS

٩٩

EMERGENCY LIGHT

EXIT


EXIT SIGN


FEDP

4 KG DRY POWDER TYPE FIRE EXTINGUISHER

### FS NOTES:

- SUFFICIENT EMERGENCY LIGHTING SHALL BE PROVIDED THROUGHOUT THE ENTIRE BUILDING IN ACCORDANCE WITH BS5266-1:2016 AND BS EN1838:2013 AND FSD CIRCULAR LETTER 6/2021
- SUFFICIENT DIRECTIONAL AND EXIT SIGN SHALL BE PROVIDED IN ACCORDANCE WITH BS5266-1:2016 AND FSD CIRCULAR LETTER 5/2008.
- 3. PORTABLE HAND-OPERATED APPROVED APPLIANCE SHALL BE PROVIDED AS REQUIRED BY OCCUPANCY.
- ACCESS IS PROVIDED FOR EMERGENCY VEHICLE TO REACH 30m OF ALL PART OF STRUCTURES.

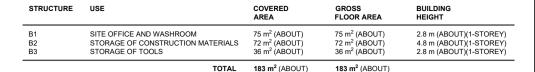

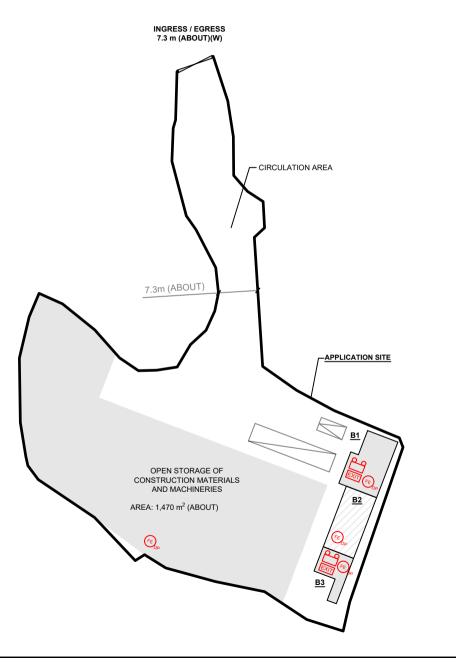



PLANNING CONSULTANT



PROJECT

PROPOSED TEMPORARY OPEN STORAGE OF CONSTRUCTION MATERIALS AND MACHINERIES WITH ANCILLARY FACILITIES FOR A PERIOD OF 3 YEARS AND ASSOCIATED FILLING OF LAND

ITE LOCATION

ANNEX III

LEGEND

APPLICATION SITE

STRUCTURE (SHED)

PARKING SPACE

INGRESS / EGRESS

STRUCTURE (ENCLOSED)

LOADING / UNLOADING SPACE

LOT 55 (PART) IN D.D. 108, PAT HEUNG, YUEN LONG, NEW TERRITORIES

SCALE	
1:700 @ A4	
DRAWN BY	DATE
MN	30.9.2024
REVISED BY	DATE
APPROVED BY	DATE
DWG. TITLE	
FSIs PROPOSAL	

002

FSD Ref.: _ 消防處檔號		<b>京</b> 统	肖防(裝置 (Regul (第九	及設備)規( ation 9(1)) 條 (1) 款)	列 VIO21V			29095
	CER	TIFICATE OF F				EQUIPMENT		
Name of 顧客姓名		下含水的族义	an Water	ation other th	Install	tomatic Fixed	Au	
Name of 樓宇名稱	Building:	<b>非滅火劑的自</b>	ater 用水化	ation using W	Install	tomatic Fixed	uΑ	
	./Town Lot: 枚/市地段 LOT 55(PA	RT) IN D.D.108		d/Estate Name: 屋苑名稱	部本系	PAT HEUNG	DC	/
Block: 座		District 分區	:	TEN LONG	Area: 地區	HK 香港	K 九龍	NT 新界
	Building 樓宇類型: Indu				nposite綜合	Licensed premise		Institutional t
	t 1 Annual Inspection C 一部 只適用於年檢	PNLY equipr 車頂 once i	nent which is installed in n every 12 months. 根	any premises shall have such	fire service inst 列第八條(b)款	allation or equipment inspected ,擁有裝置在任何處所內!	d by a registered	contractor at least
Code編碼 (1-35)	Type of FSI 裝置類型	Location(s) 位置	Comment on	Condition 狀況評刻	党 完	Completion Date 或日期(DD/MM/YY)		Due Date ] 日 (DD/MM/YY)
					M gni	ergency Light		
					執示師	t Sign # u#		910
			亲统		m (MF	a Alarm Syste	Fin	
				が控制中心	re ig le		Fin	
				社会原则是从	e mote	Detection Sy	ni'i Bi	
Part 2 第	二部 Installation / Mod	dification / Repair	/ Inspection	work 裝置/改裝	/修理/	檢查工作	Fire	
Code編碼 (1-35)	Type of FSI 装置類型	Location(s) 位置	School and series	Carried out 完成之工作		nment on Condition 狀		ompletion Date 日期(DD/MM/YY)
11	2x 應急照明燈	AS ABOVE		del: TS-EL 2052	(門 香)	Conforms with F	Carlotte Chi	23-9-2024
12	2 x 出口指示燈箱	ice 認可的自		全新安裝方向出路燈箱 ("APOLLO")		ed Automatics	Fix	446
			_	<b>E泡沫系統</b>	ms E		Fix	000
	·				stem		Gas	
				瓦體排放系統	mater	Extraction Sy	Gas	
	三部 Defects 損壞事項			1. 14a 1.1 mil		e Reel 消防。	15051	44 m4
Code編碼 (1-35)	Type of FSI 裝置類型	Location(s) 位置	- Section - Sect	g Defects 未修缺點	deingn	Comment on D	elects 缺點	計処
	主手提器具	可的人手操化	pliance tg		erated			125
					Stairca			80
	水管系統	<b>亡水泵的環狀</b>	) 裝有固足	Fixed Pump(s	n with			10
					花漉净	inkler System		285
		A	式排煙系	System 静態		ic Smoke Ext	Stat	
working order Equipment and	ertify that the above installations/equ in accordance with the Codes of P d Inspection, Testing and Maintenance	ractice for Minimum Fire e of Installations and Equip	Service Installations	and Signati	ure :	H. H. H. A.	5	For FSD use only:
	Director of Fire Services. Defects are l 證明以上之消防裝置及設		生能良好,符		me: 100	LI SAU PING	Te.V	Ingresial
合消防處	處長不時公佈的最低限度檢查測試及保養守則的規	之消防裝置及設行	<b>葡宁则與装置</b>	FSD/RC N 消防處註冊號	Vo. :	RC 2/163 RC 1	BW E	Inspected
	登書涉及年檢事			Company Na 公司名		Intercept Fire &	Security	
794 R				AHIA	11.1	Tech.Ltd	- AFFERDANCE	Key-in

Telephone:聯絡電話

Date:

23-9-2024

This certificate should be displayed at prominent location of the building or premises for FSD's inspection if any annual maintenance work is involved. F.S. 251 (Rev. 1/2016)

或處所當眼處以供消防處人員查核

working order in accordance with the Codes of Practice for Minimum Fire Service Installations and Equipment and Inspection, Testing and Maintenance of Installations and Equipment published from time to time by the Director of Fire Services. Defects are listed in Part 3.

本人藉此證明以上之消防裝置及設備經試驗,證明性能良好,符 合消防處處長不時公佈的最低限度之消防裝置及設備守則與裝置 及設備之檢查測試及保養守則的規格,損壞事項列於第三部

# 如證書涉及年檢事項,應張貼於大廈 或處所當眼處以供消防處人員查核

This certificate should be displayed at prominent location of the building or pi for FSD's inspection if any annual maintenance work is involved.

F.S. 251 (Rev. 1/2016)

受權人簽署

Name: 姓名

FSD/RC No. 消防處註冊號碼

Company Name: 公司名稱

Telephone : 聯絡電話 Date

日期

21-8-2024

RC 3/185

Tech.Ltd

Intercept Fire & Security

Inspected

Key-in

Verified